

CARPARK (NORTH)

MULTI-PURPOSE BUILDING

MIDDLE LEARNING COMMUNITY BUILDING

SENIOR LEARNING COMMUNITY BUILDING

ADMINISTRATION BUILDING

CARPARK (SOUTH)

JUNIOR LEARNING COMMUNITY BUILDING

EXISTING BUS LOOP ROAD

SWIMMING POOL

LEGEND EXISTING SHADE SAIL EXISTING TREE EXISTING PATHWAY PROPOSED PATHWAY NOTES
TREES & FLORA LOCATIONS SHOWN
INDICATIVELY. REQUIRED REMOVALS TO BE
FURTHER DEVELOPED IN DESIGN DEVELOPMENT
STAGE REV DATE BY CH DESCRIPTION
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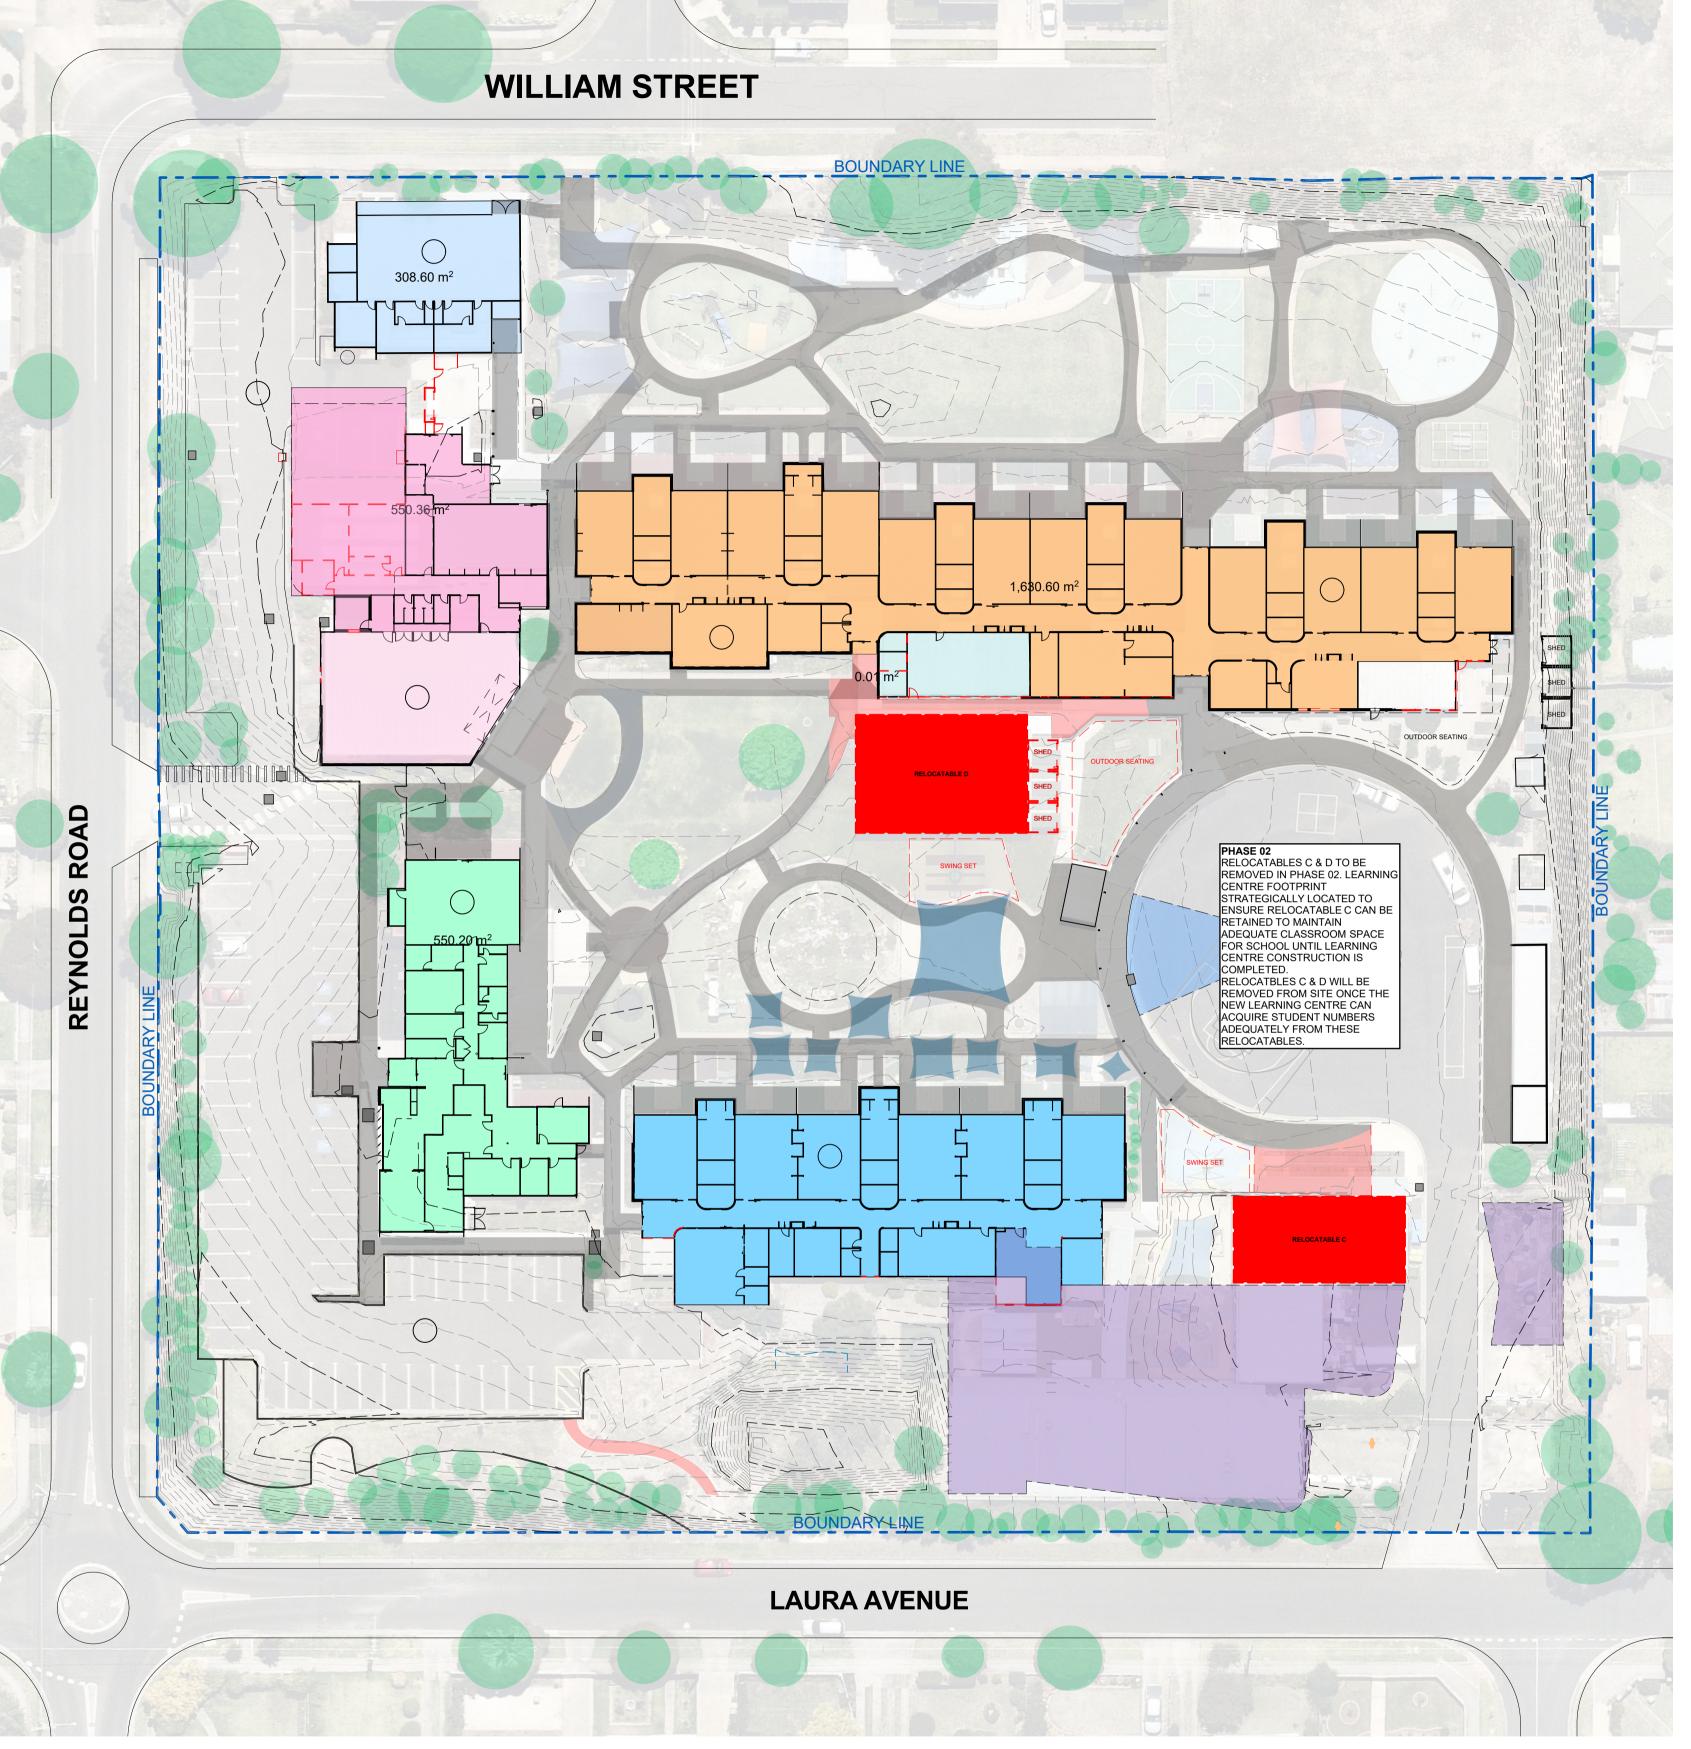
PROJECT

2105

DWG NO.

DD.00.03 | A

NOTES



CARPARK (NORTH)

MULTI-PURPOSE BUILDING

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SENIOR LEARNING COMMUNITY BUILDING

ADMINISTRATION BUILDING

CARPARK (SOUTH)

JUNIOR LEARNING COMMUNITY BUILDING

EXISTING BUS LOOP ROAD

SWIMMING POOL

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STAGE
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 DESCRIPTION

 A
 27/04/21
 JM
 DC
 SD REPORT ISSUE

 B
 30/04/21
 JM
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#Contact Full Name

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10/06/2021

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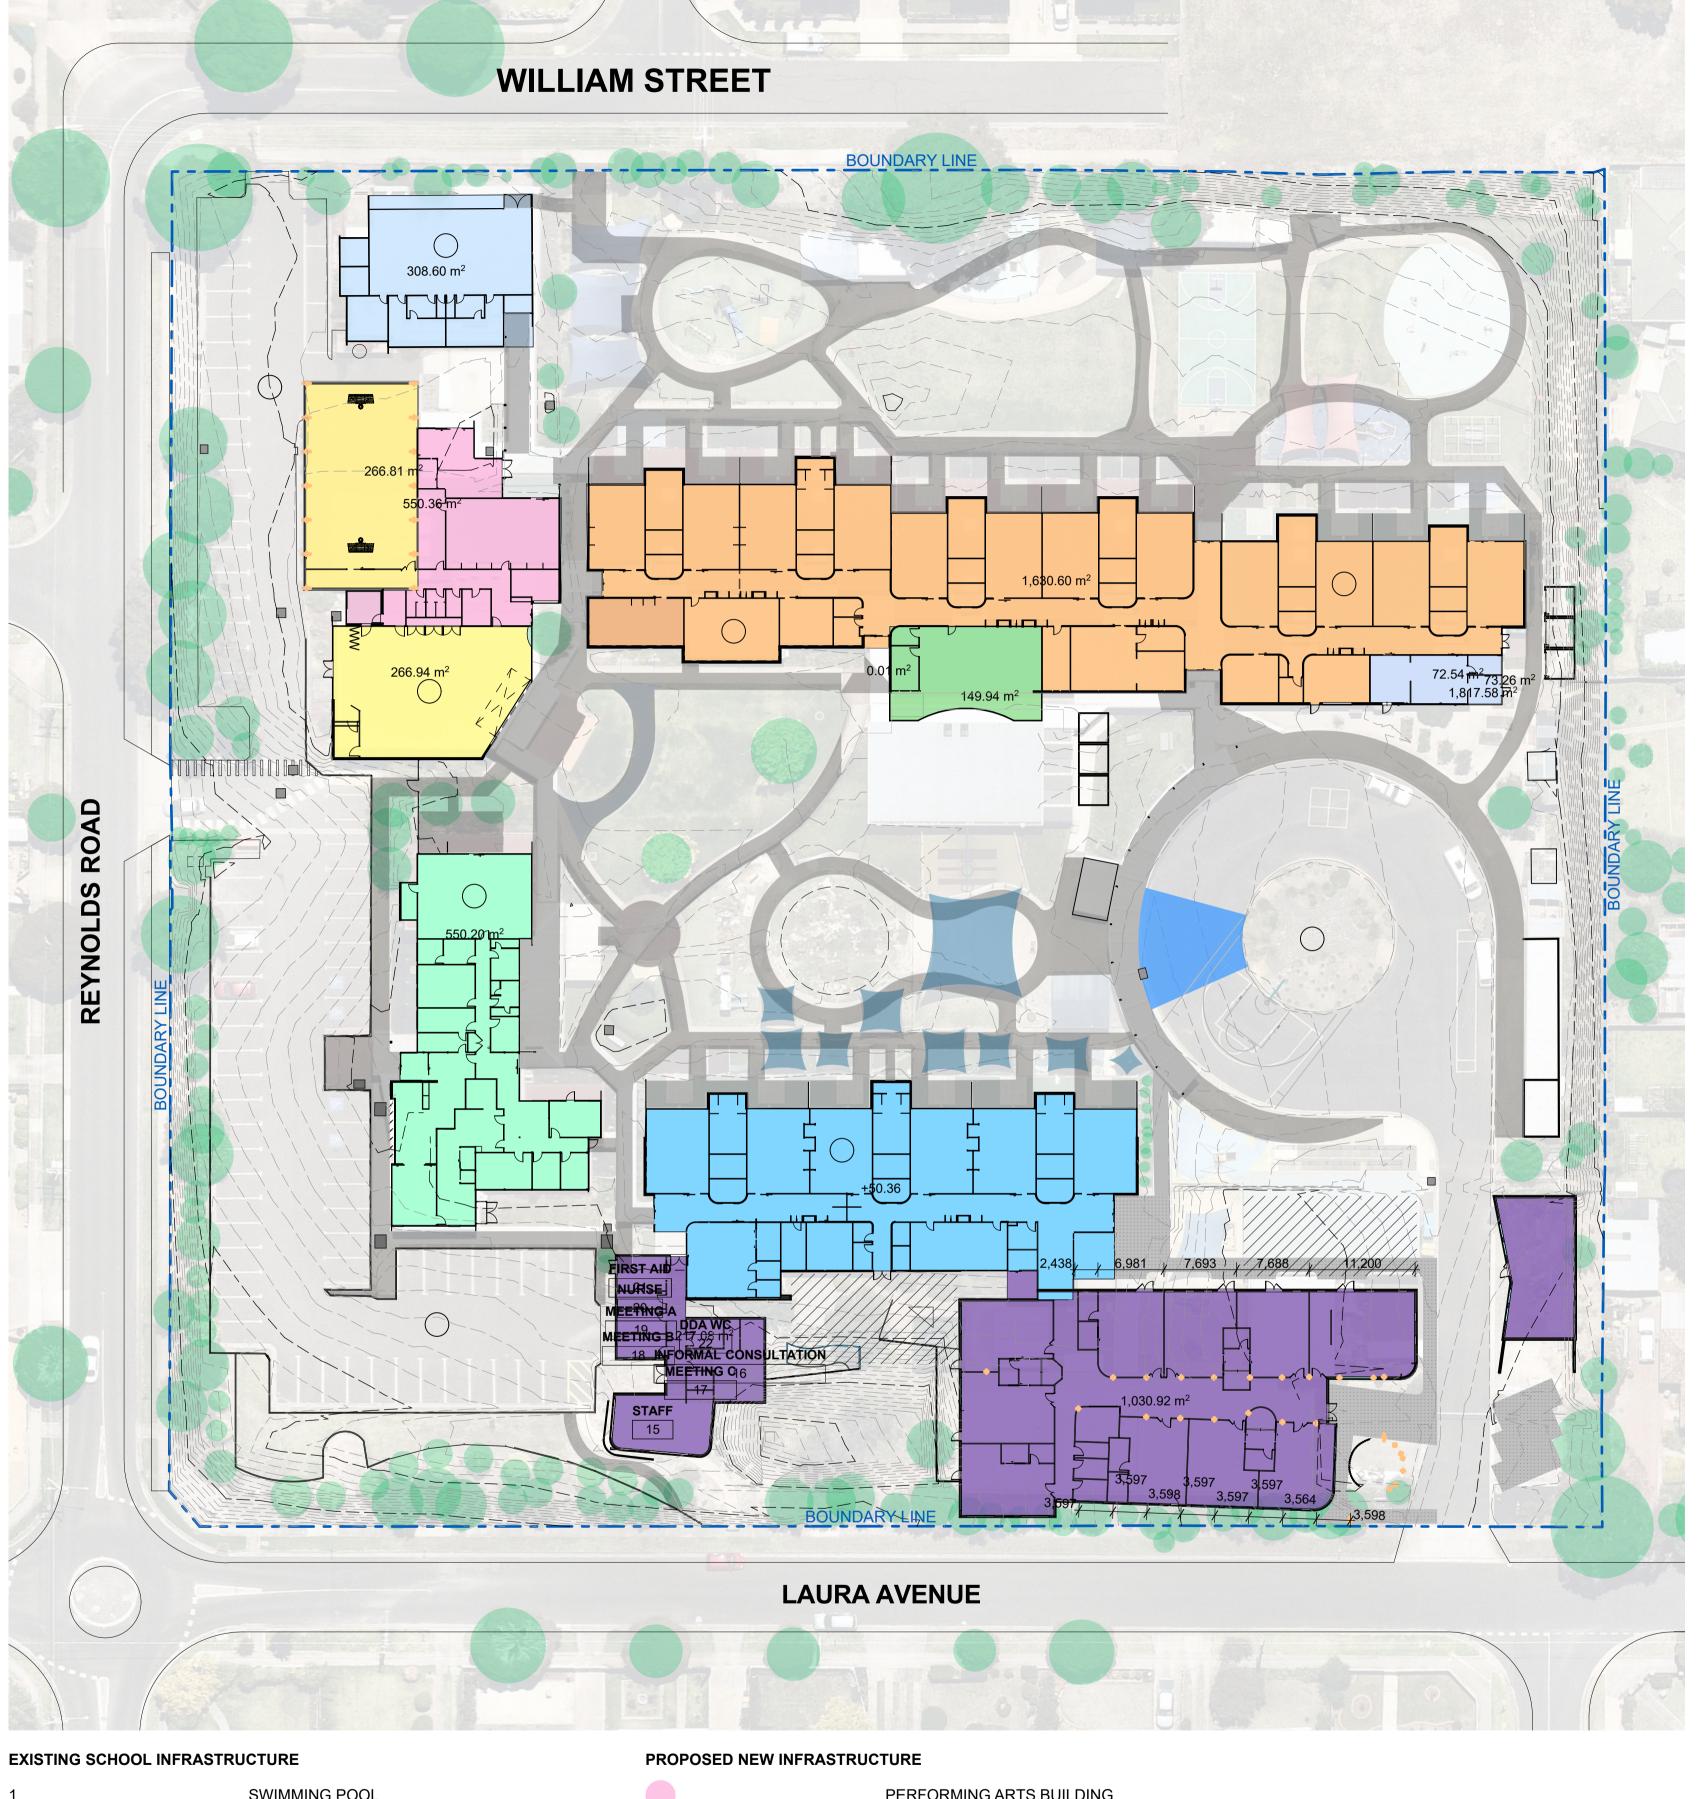
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PROJECT

2105

PLOT DATE



SWIMMING POOL CARPARK (NORTH) MULTI-PURPOSE BUILDING MIDDLE LEARNING COMMUNITY BUILDING SENIOR LEARNING COMMUNITY BUILDING ADMINISTRATION BUILDING CARPARK (SOUTH) JUNIOR LEARNING COMMUNITY BUILDING

EXISTING BUS LOOP ROAD

PERFORMING ARTS BUILDING STEAM HUB THERAPY HUB LEARNING CENTRE

BUS SHELTER EXTENSION (DESIGN TBC)

NOTES LEGEND EXISTING SHADE SAIL EXISTING TREE EXISTING PATHWAY PROPOSED PATHWAY
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3216

Victorian School Building Authority


CAD FILE 2105 BVS Stage 2 - DD

Barwon Valley School - Stage 2

Stage 2 Masterplan


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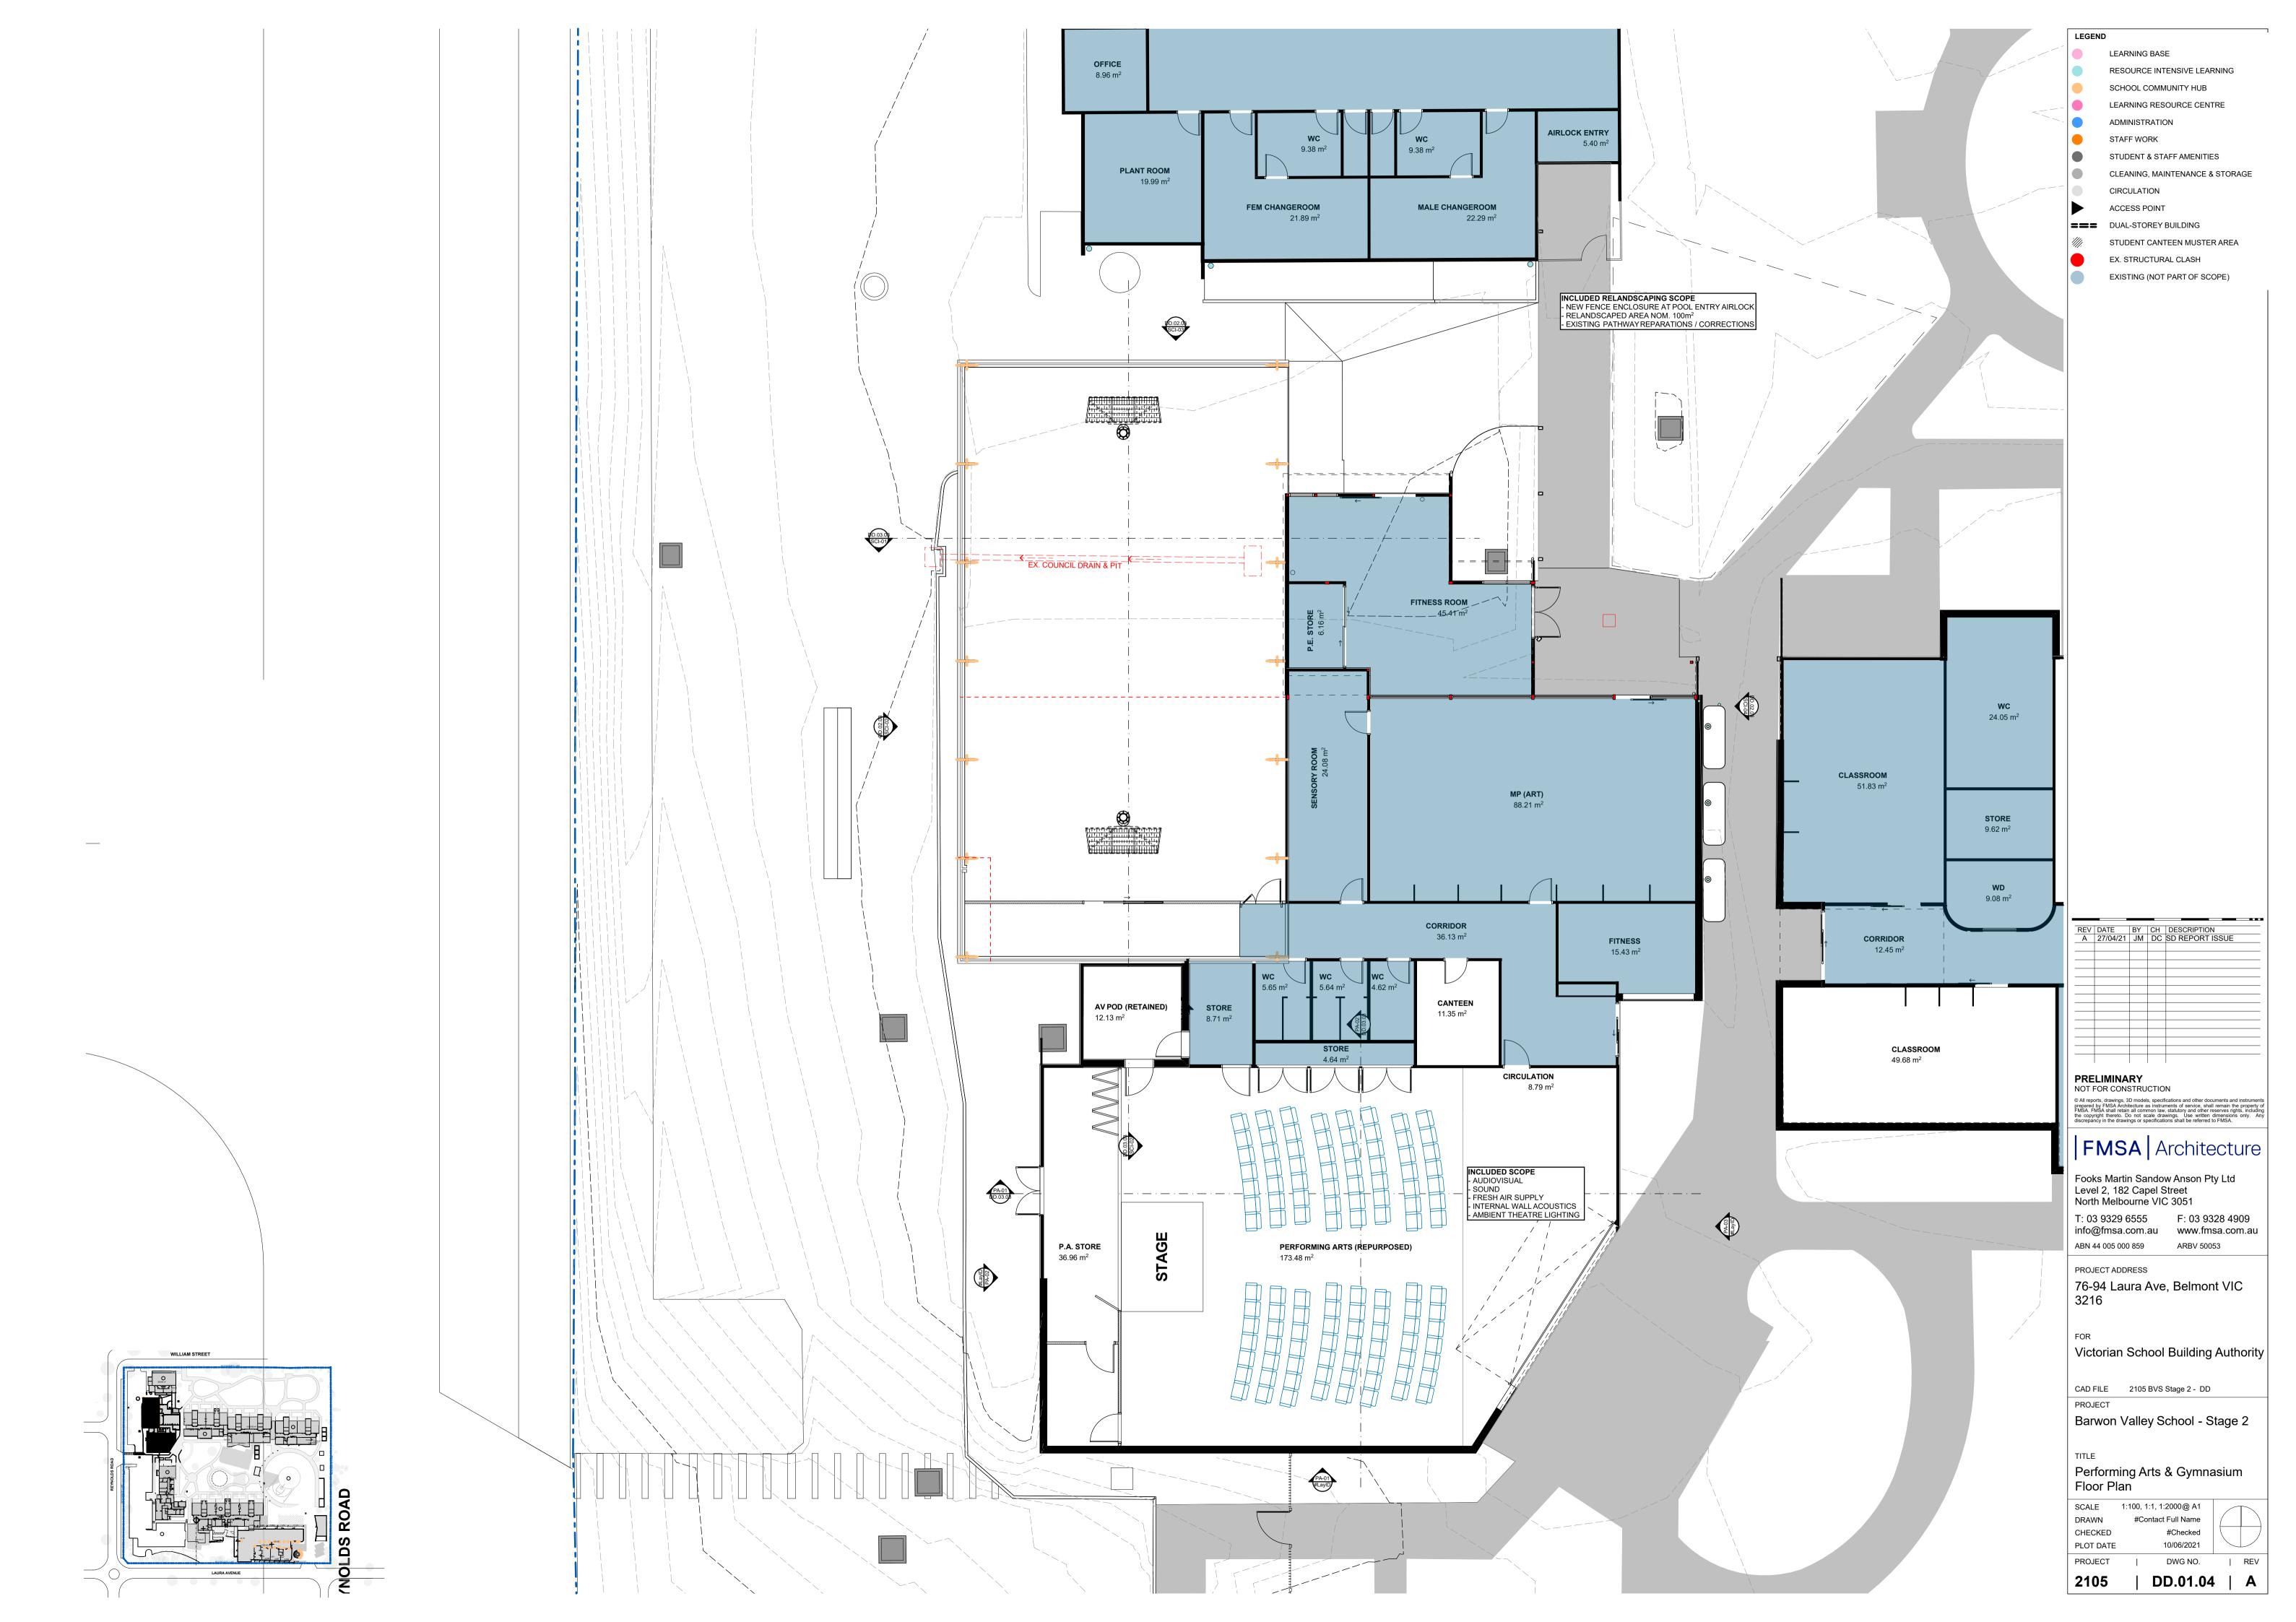


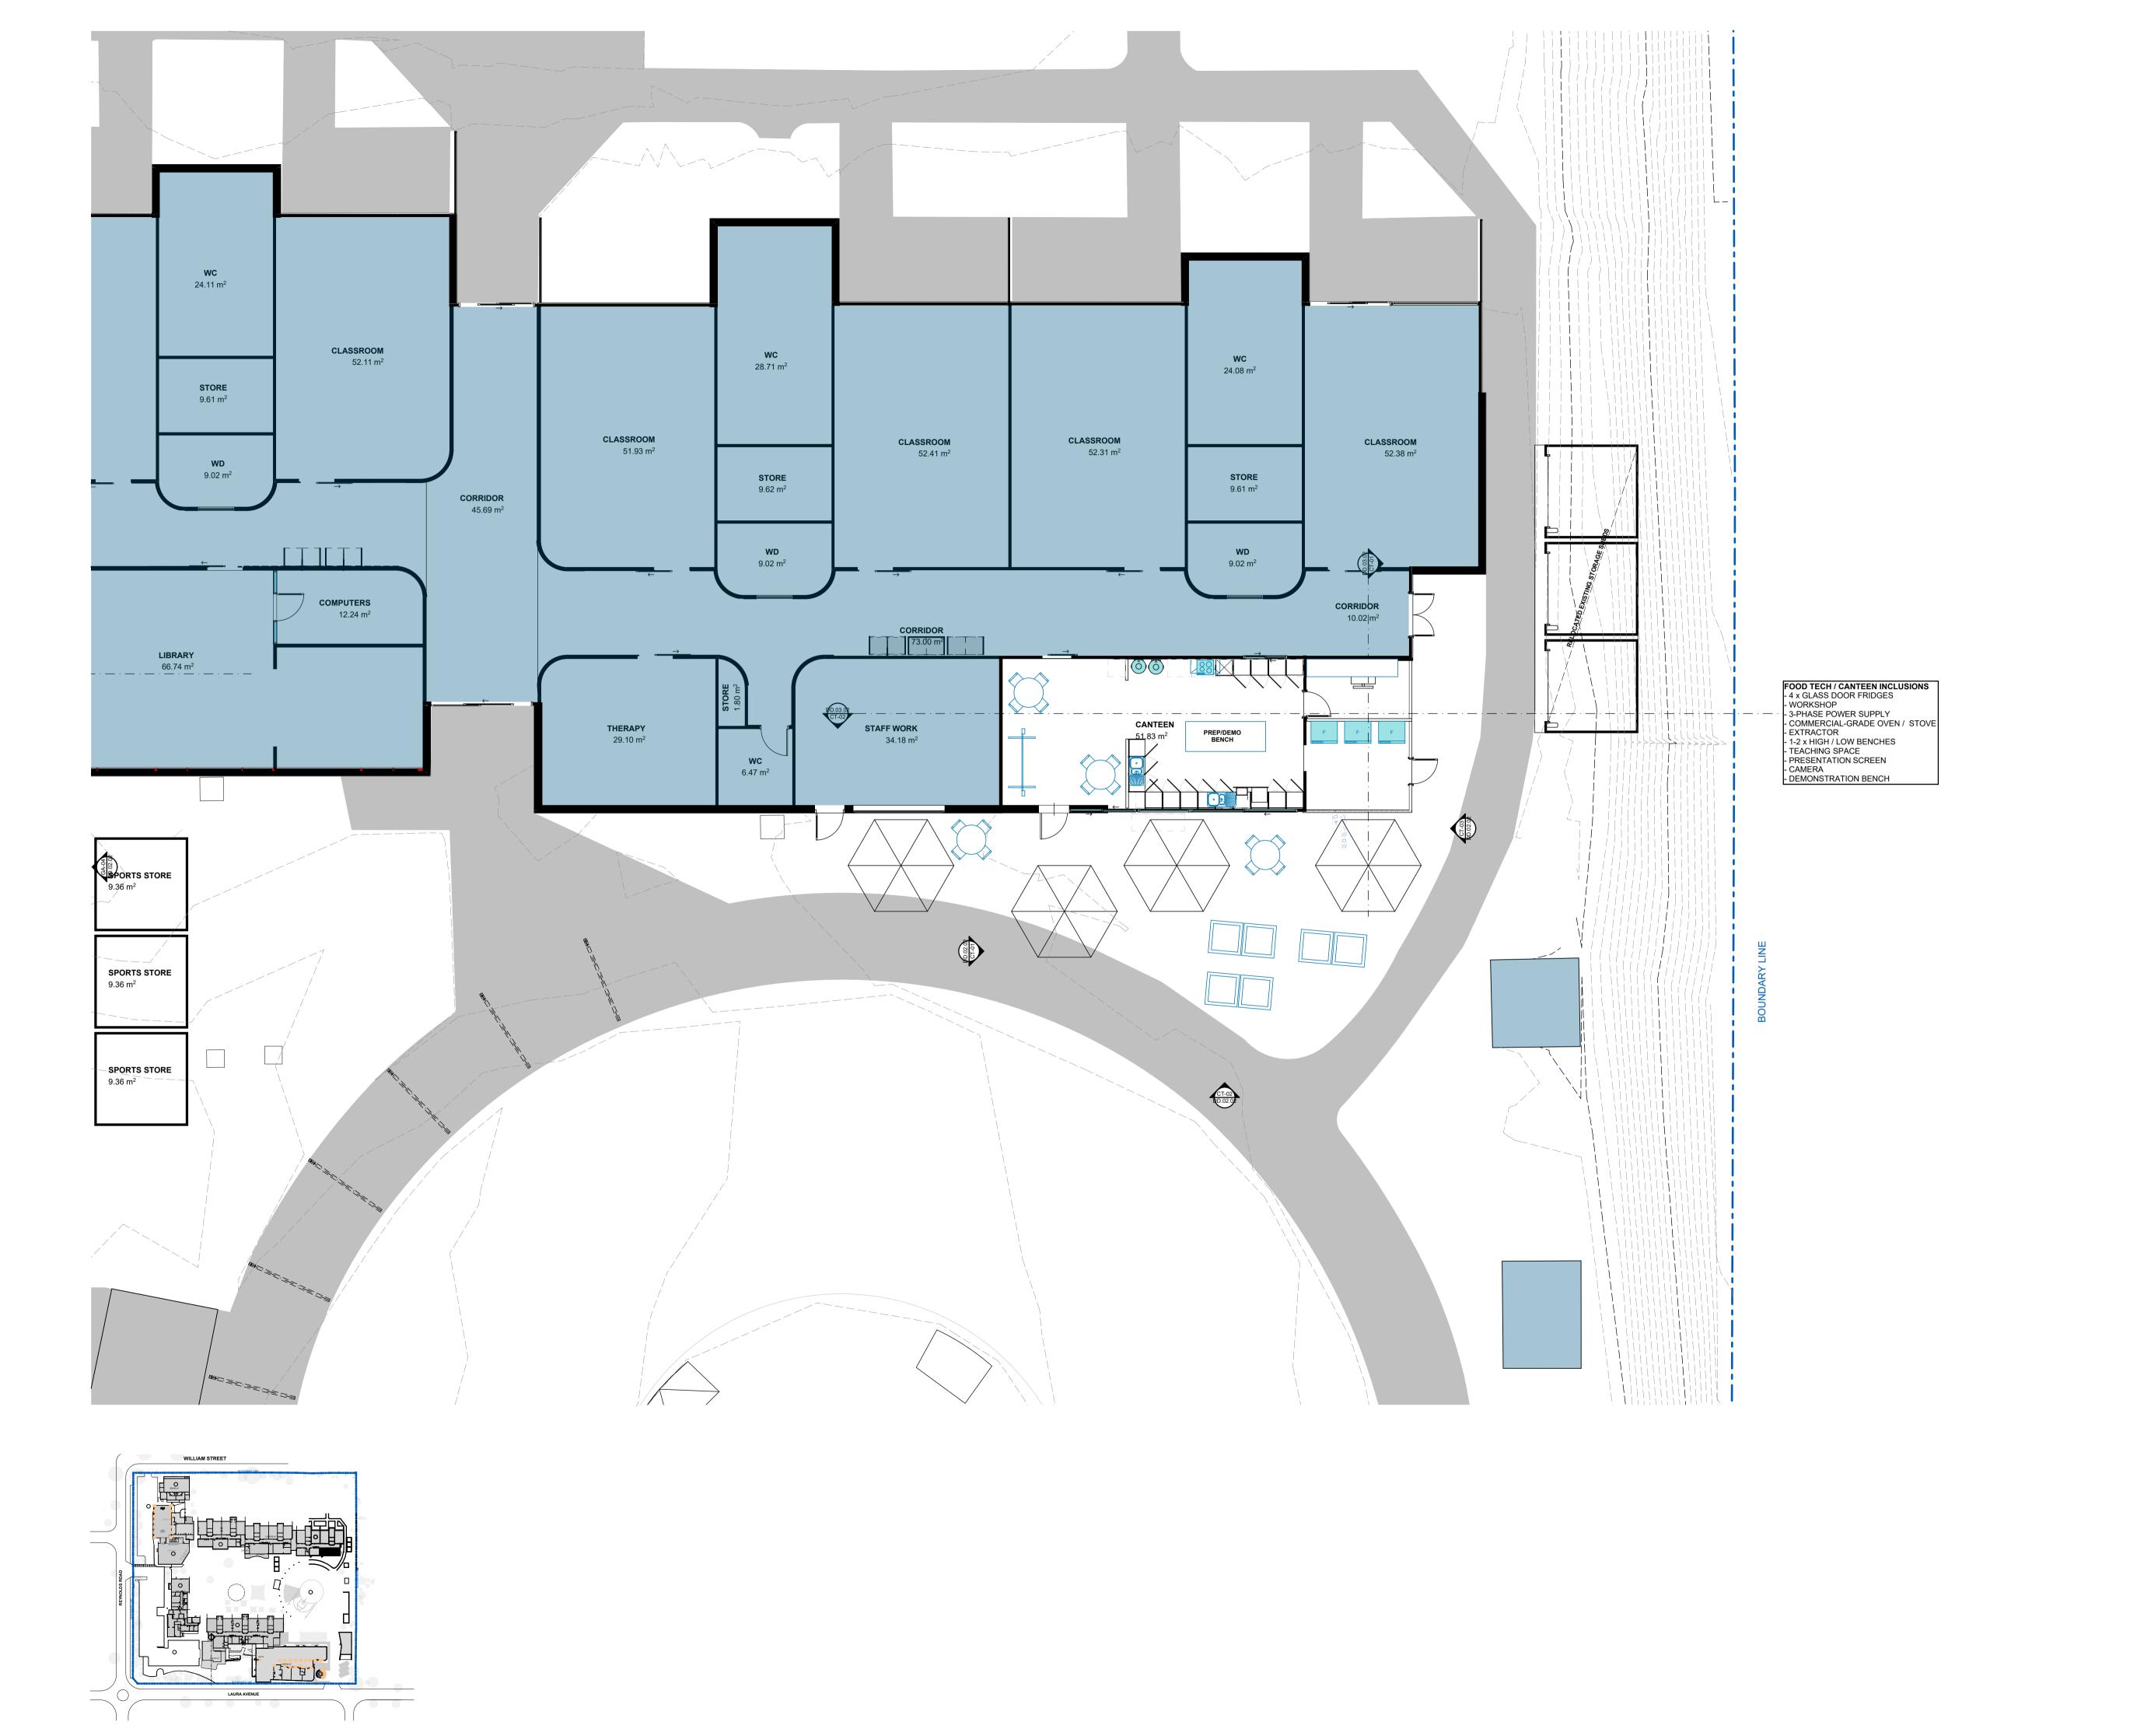


LEARNING BASE RESOURCE INTENSIVE LEARNING SCHOOL COMMUNITY HUB LEARNING RESOURCE CENTRE ADMINISTRATION STAFF WORK STUDENT & STAFF AMENITIES CLEANING, MAINTENANCE & STORAGE CIRCULATION ACCESS POINT === DUAL-STOREY BUILDING STUDENT CANTEEN MUSTER AREA EX. STRUCTURAL CLASH EXISTING (NOT PART OF SCOPE) REV DATE BY CH DESCRIPTION
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LEGEND





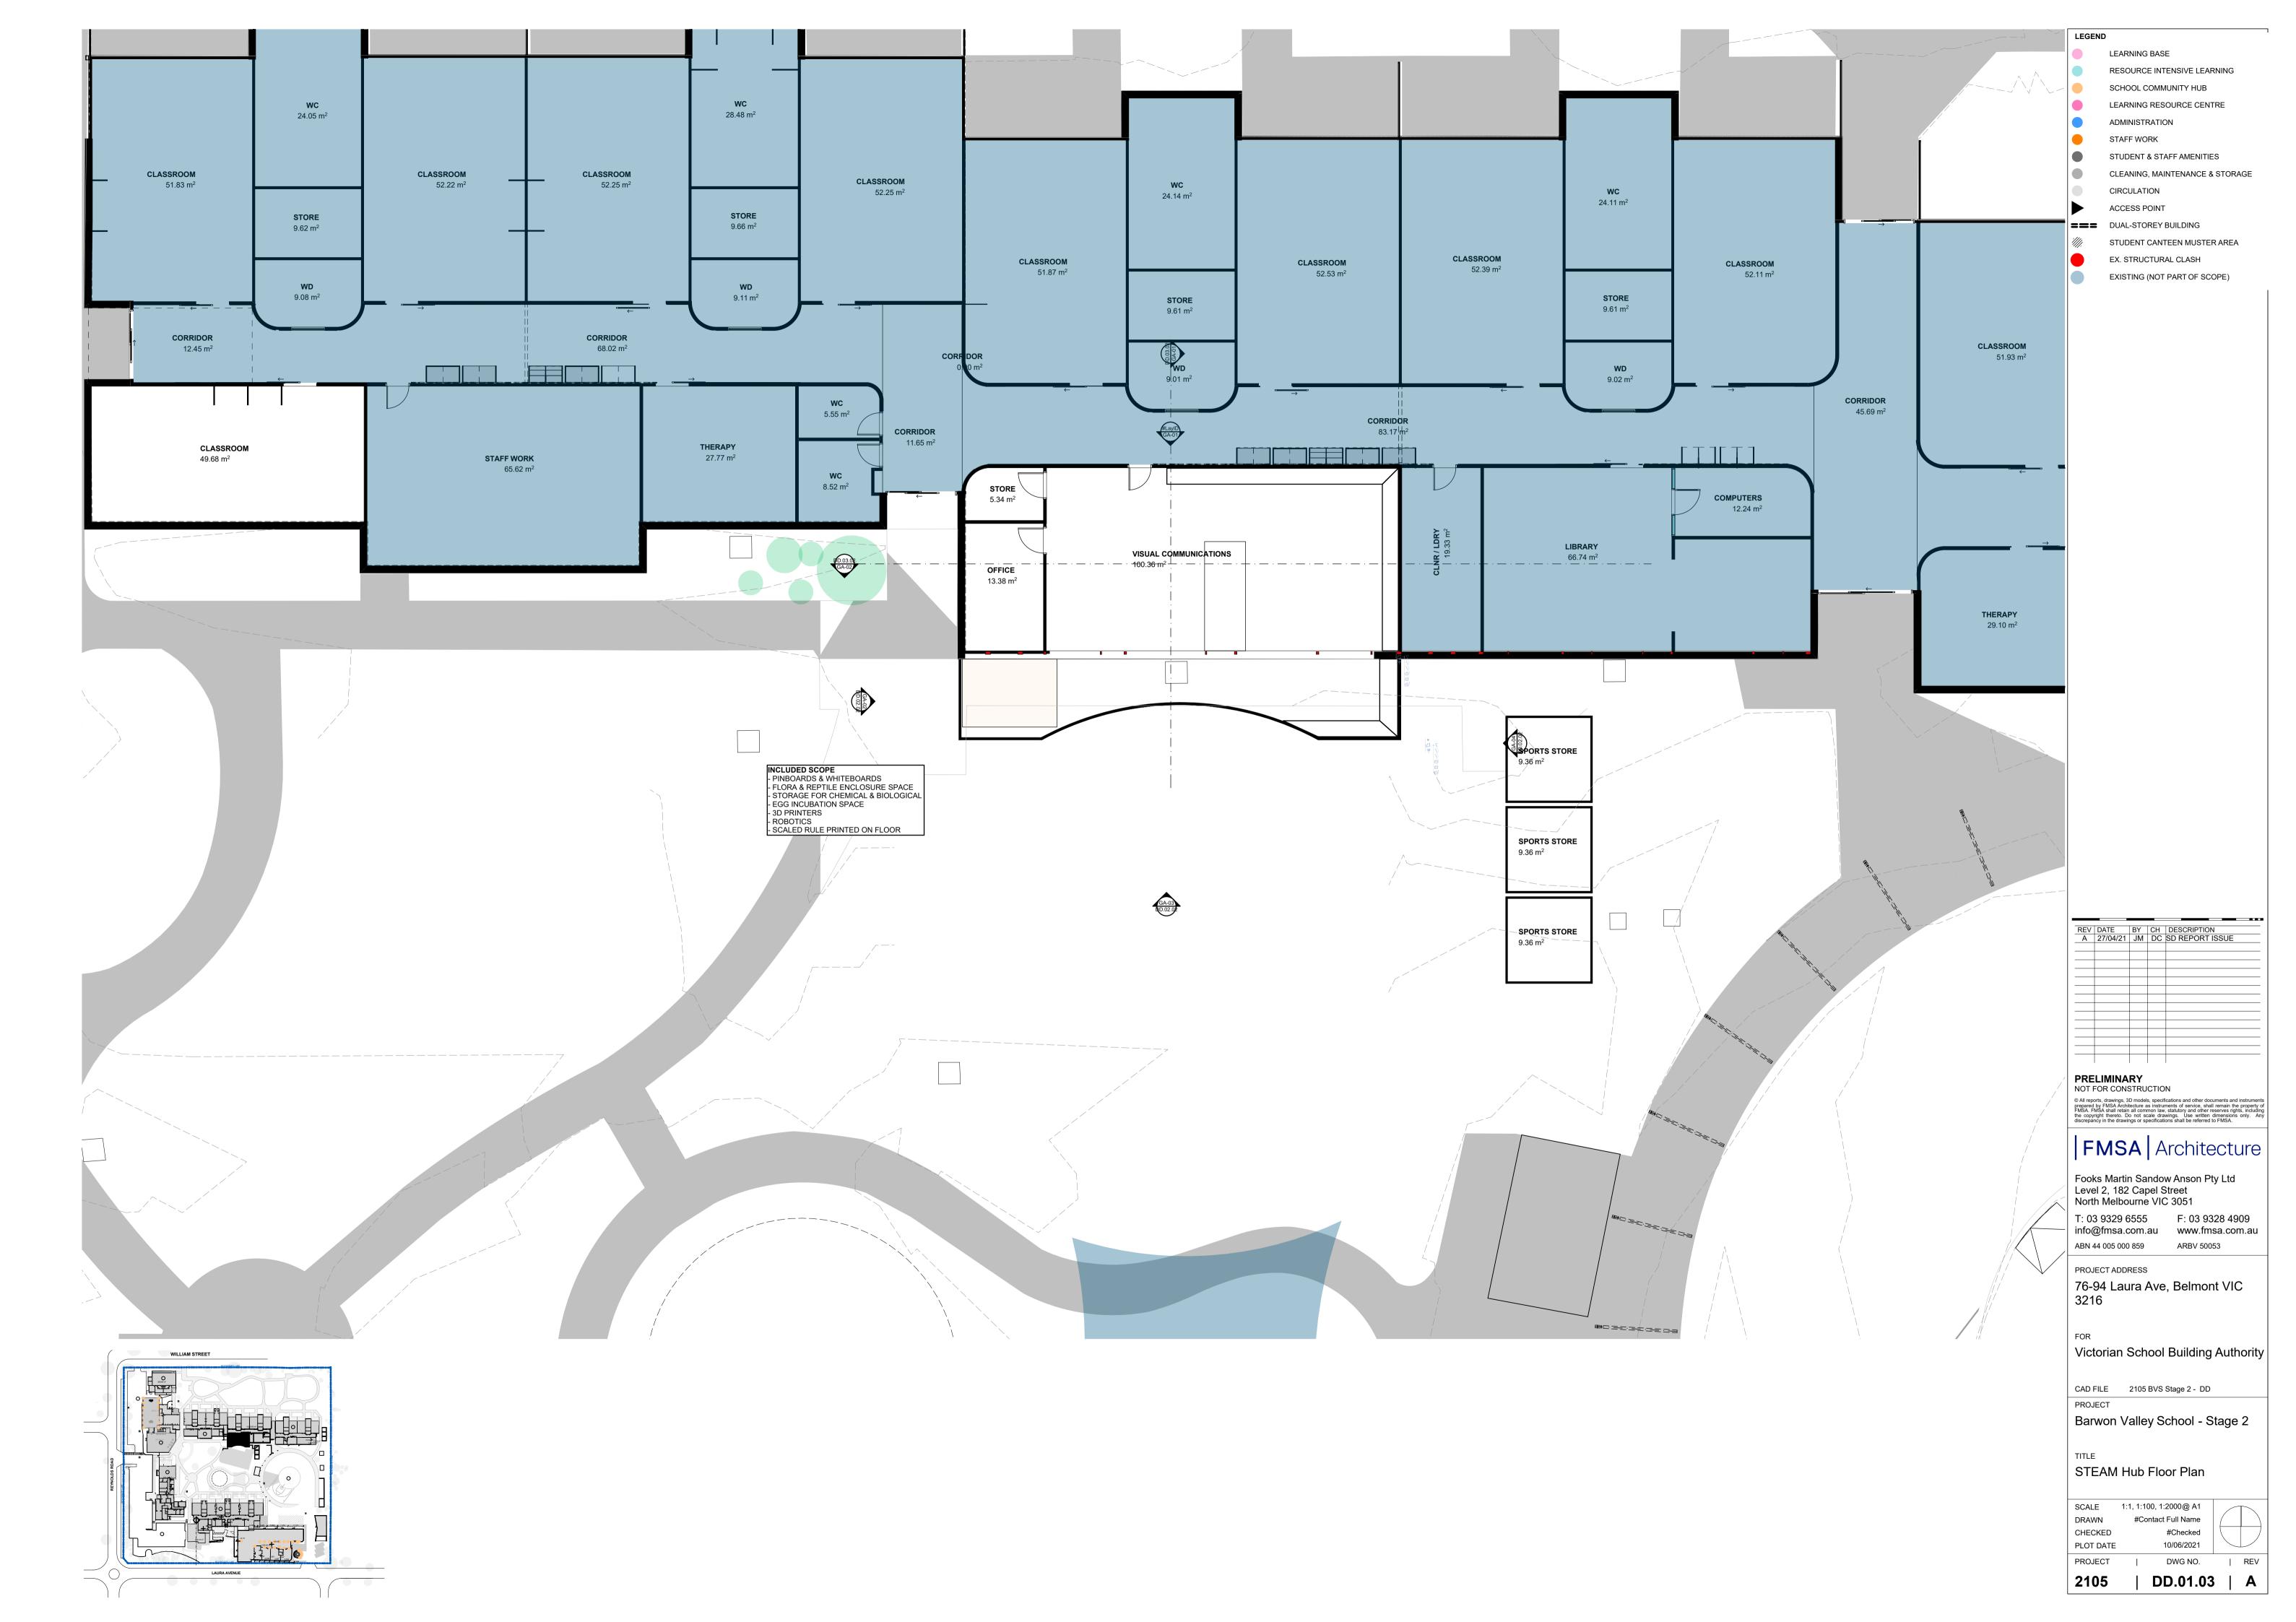

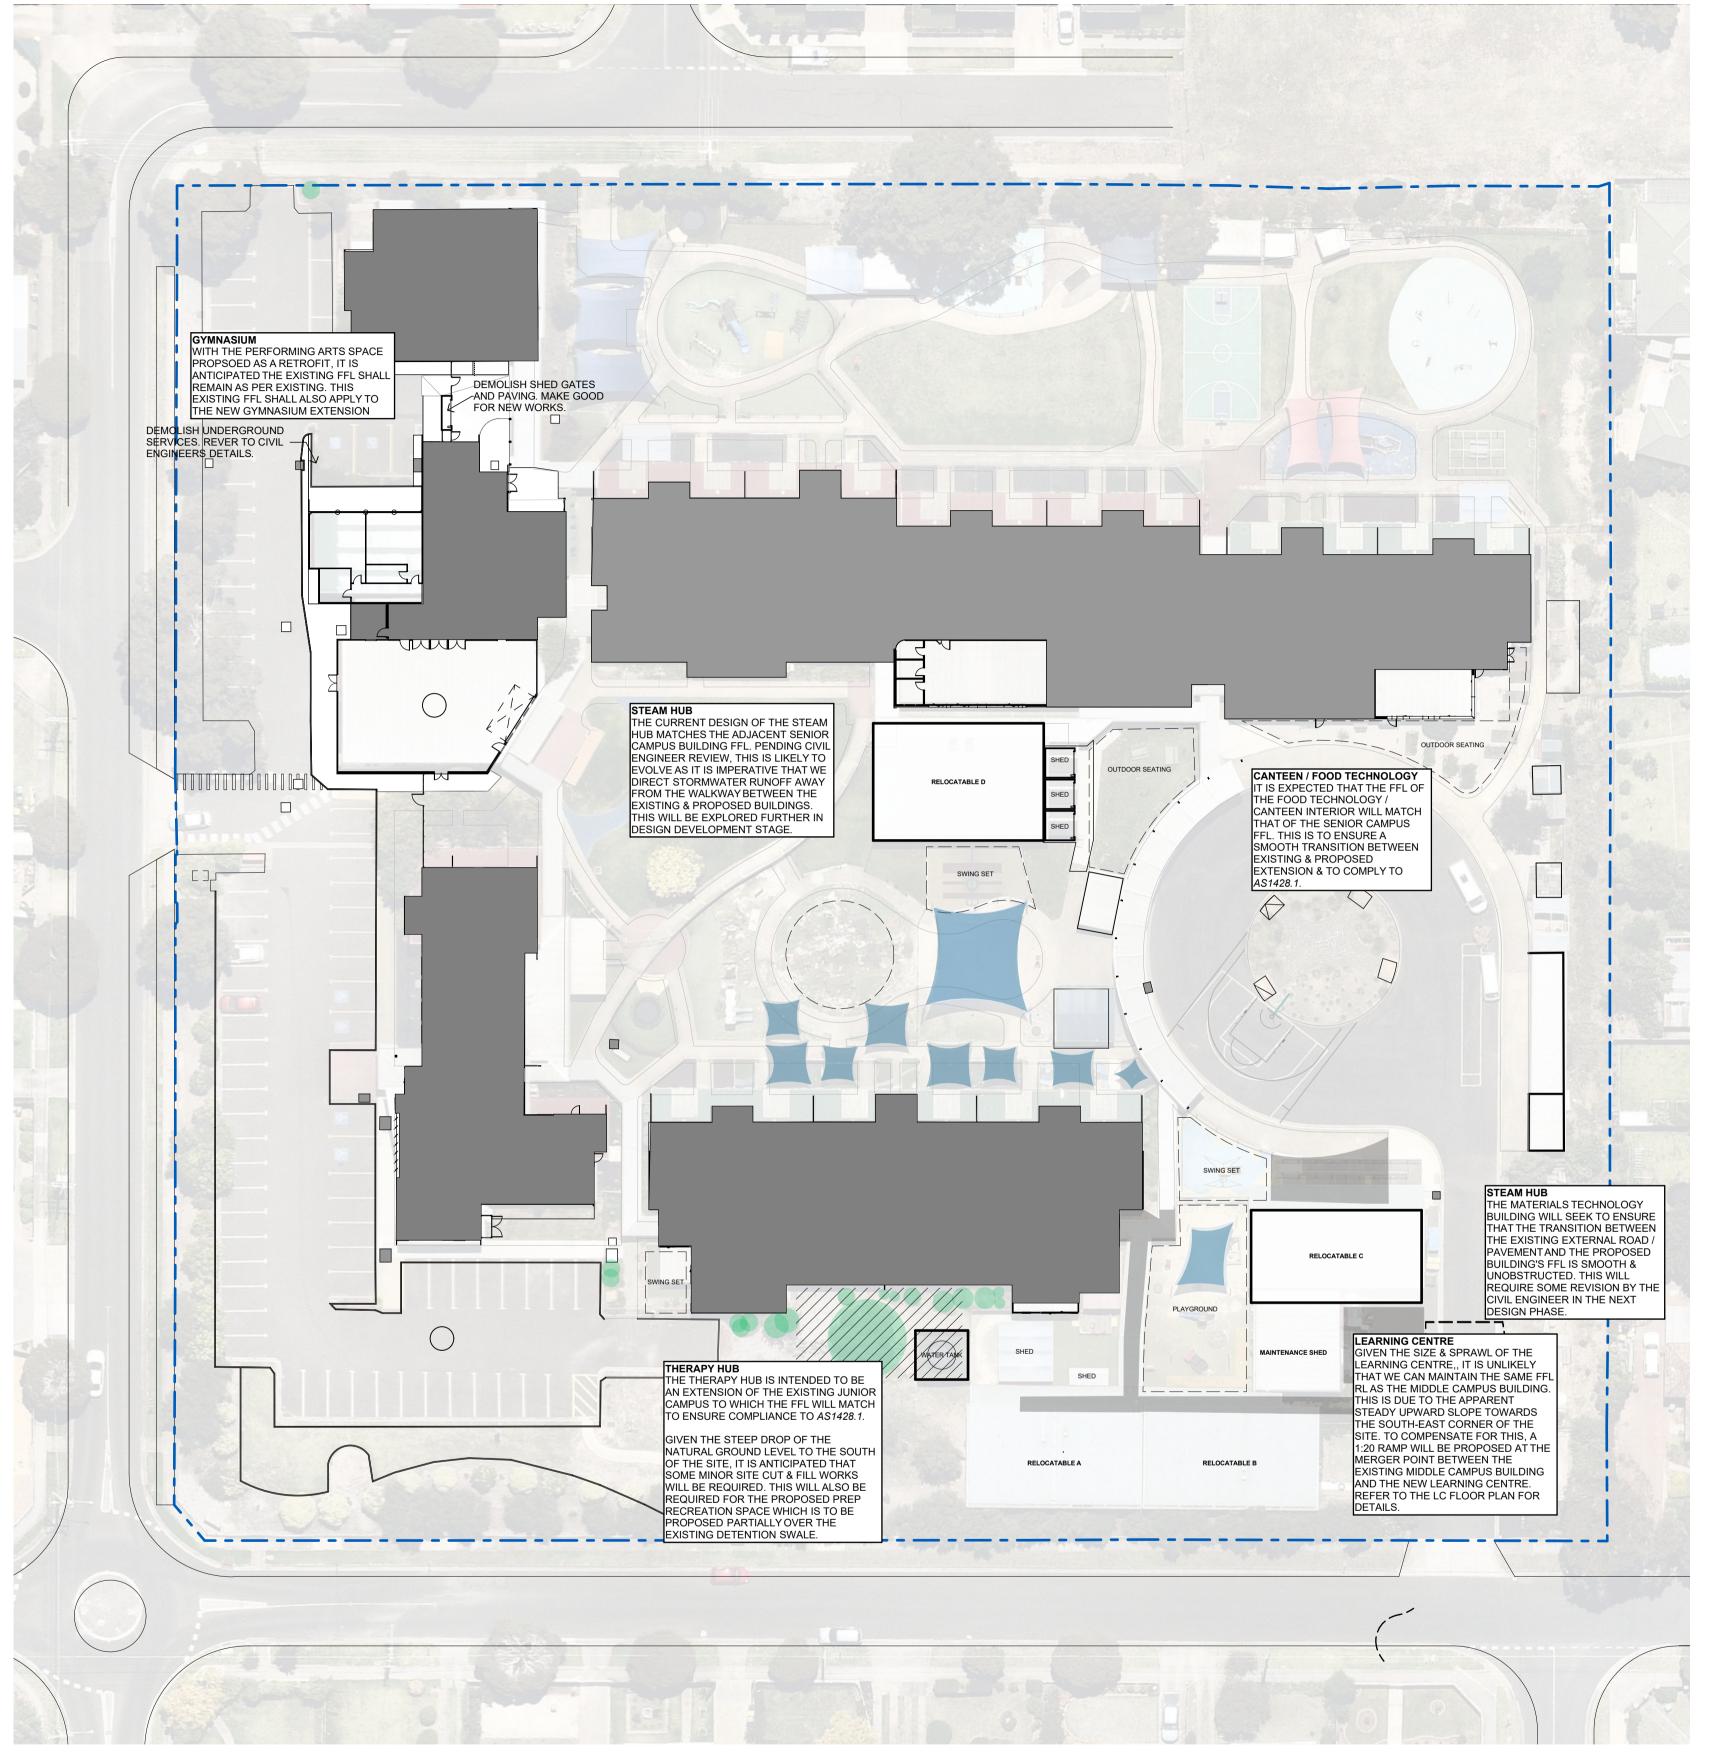

SWIMMING POOL

CARPARK (NORTH)

MULTI-PURPOSE BUILDING

MIDDLE LEARNING COMMUNITY BUILDING

SENIOR LEARNING COMMUNITY BUILDING

ADMINISTRATION BUILDING

CARPARK (SOUTH)

JUNIOR LEARNING COMMUNITY BUILDING

EXISTING BUS LOOP ROAD

NOTES LEGEND

EXISTING SHADE SAIL



EXISTING PATHWAY

PROPOSED PATHWAY

THE INFORMATION SHOWN ON THIS EXISTING CONDITIONS MASTERPLAN SHOWN IS HEAVILY CONCENTRATED. FOR ALL IDENTIFIED SITE SERVICES IDENTIFIED BY THE SITE SERVICES INVESTIGATION, PLEASE REFER TO APPENDICES 23 OF THIS SKETCH DESIGN

NO AREAS OF THE SITE HAVE BEEN AFFECTED BY CONTAMINATION OR FILL; REFER TO APPENDICES 23 FOR MORE DETAILS.

REV	DATE	BY	СН	DESCRIPTION
01	14/07/2021	JP.	JM	DD DESIGN MEETING
02	16/07/2021	JP	JM	FOR QS REVIEW
03	27/07/2021	JP	JM	FOR BUILDING SURVEYOR

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> PROJECT ADDRESS 76-94 Laura Ave, Belmont VIC

3216

Victorian School Building Authority

ARBV 50053


CAD FILE 2105 BVS Stage 2 - DD

Barwon Valley School - Stage 2

Existing Conditions Plan

SCALE		1:400@ A1	
DRAWN		JP	
CHECKED		JM	
PLOT DATE		27/07/2021	
PROJECT		DWG NO.	R

2105 | DD.00.01 | 03

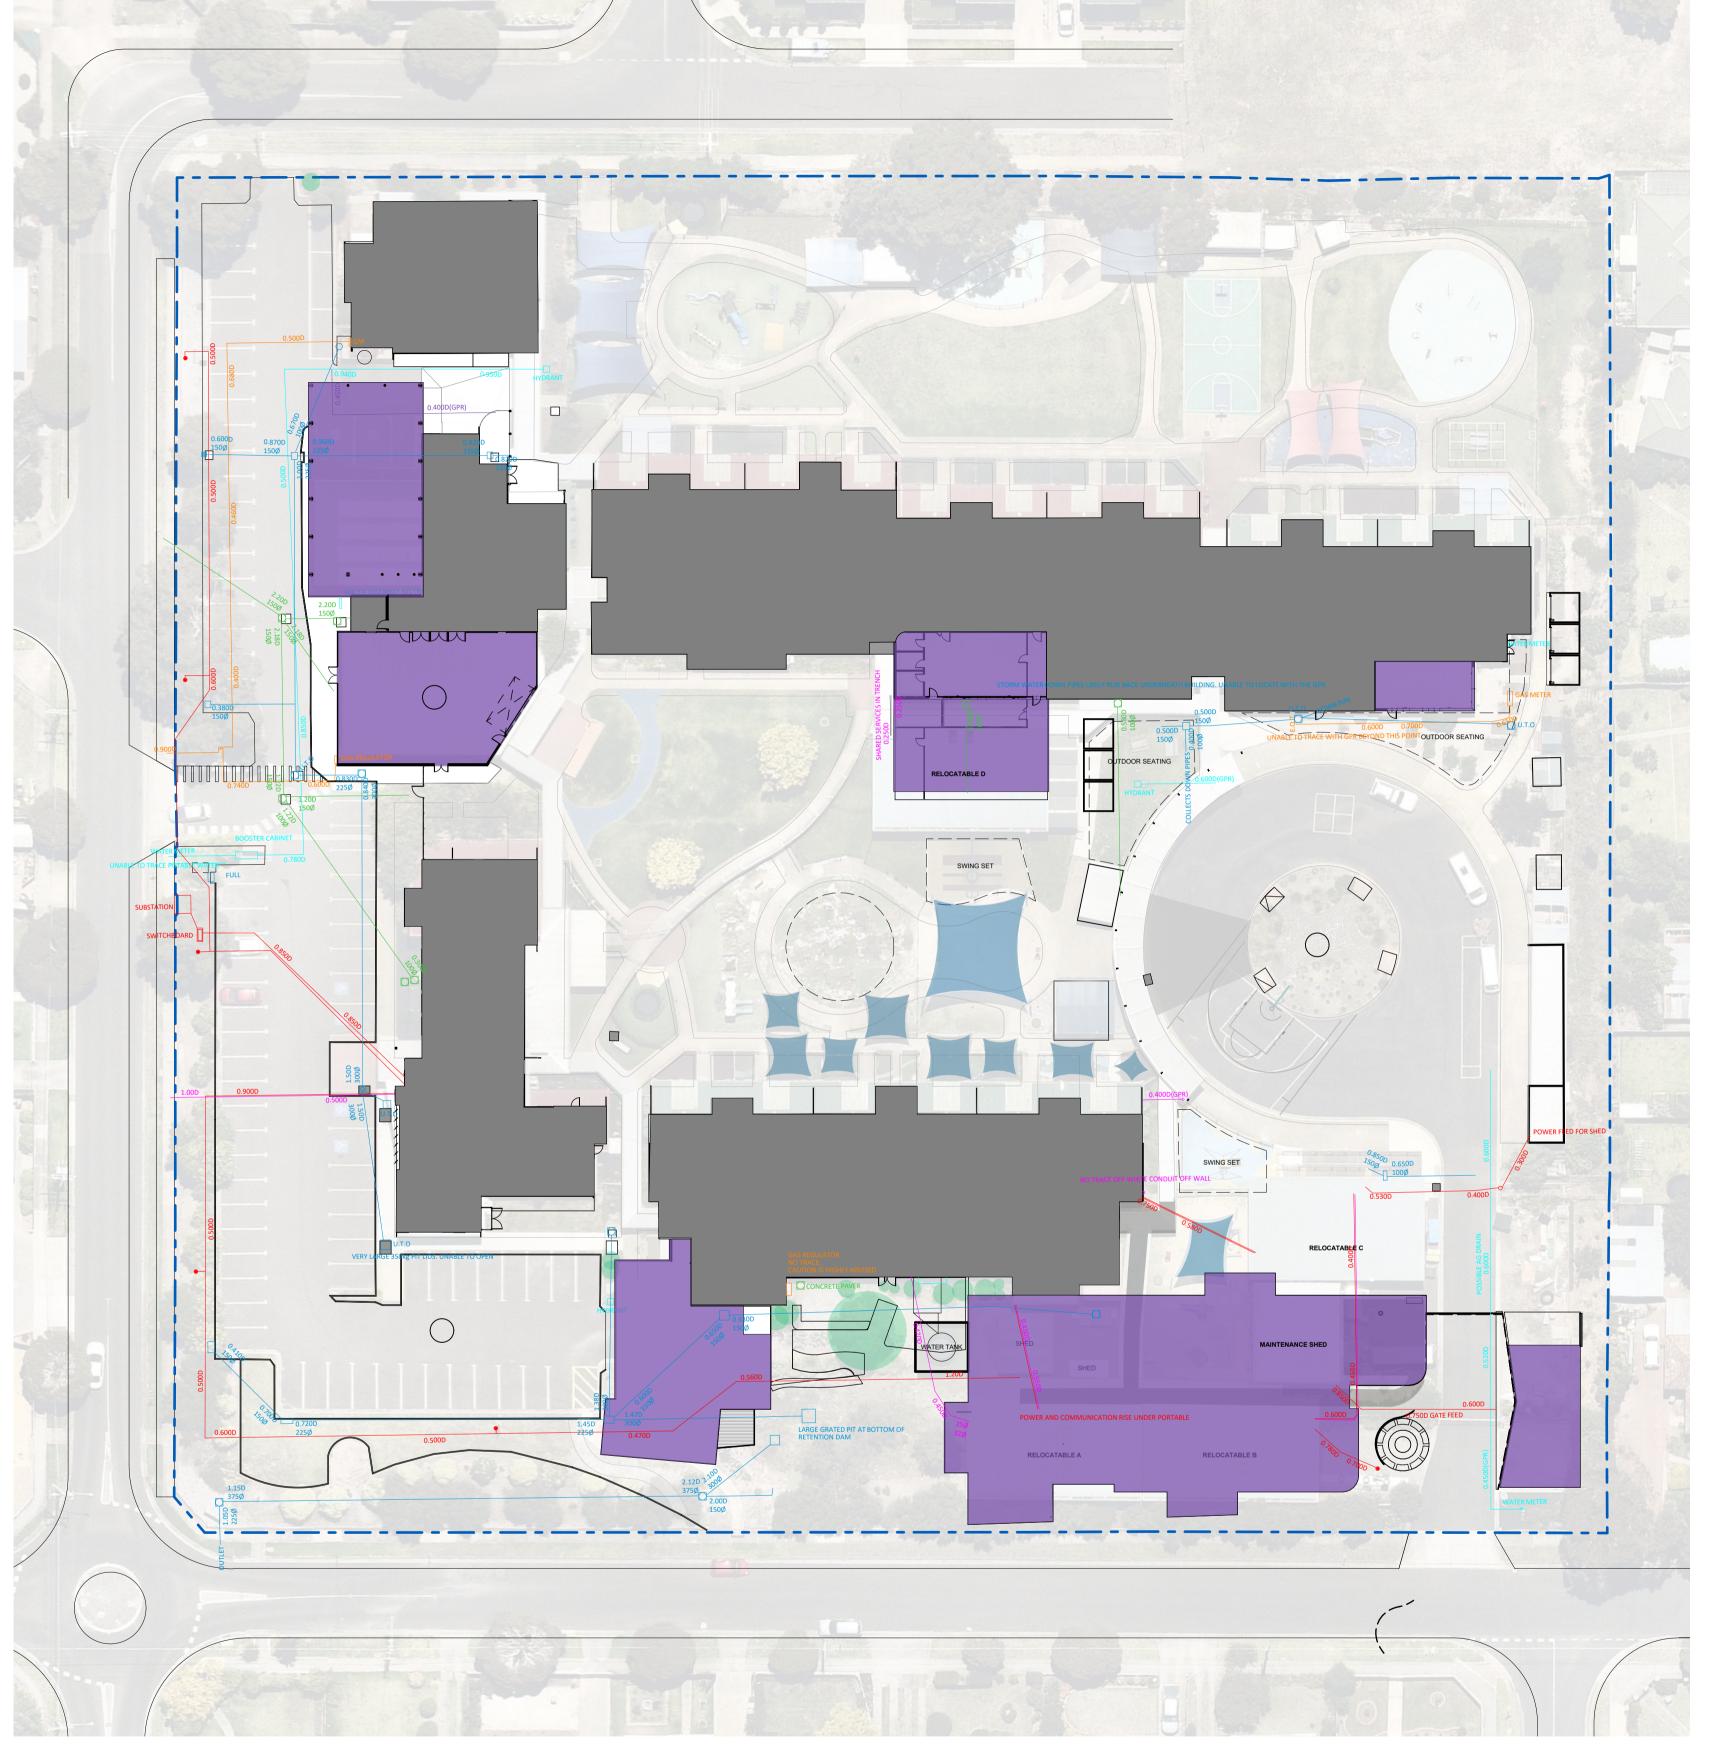

CARPARK (NORTH)

MULTI-PURPOSE BUILDING

MIDDLE LEARNING COMMUNITY BUILDING

SENIOR LEARNING COMMUNITY BUILDING

ADMINISTRATION BUILDING

CARPARK (SOUTH)

SWIMMING POOL

8 JUNIOR LEARNING COMMUNITY BUILDING

EXISTING BUS LOOP ROAD

NOTES LEGEND EXISTING SHADE SAIL EXISTING TREE EXISTING PATHWAY PROPOSED PATHWAY EXISTING COMMS SERVICES EXISTING GAS SERVICES EXISTING POWER SERVICES EXISTING SEWER SERVICES EXISTING STORMWATER SERVICES EXISTING WATER SERVICE UNKNOWN TARGET - SERVICE NOTES
EXISTING SITE SERVICES LOCATIONS
INDICATIVELY SHOWN
 REV
 DATE
 BY
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 DESCRIPTION

 01
 14/07/2021
 JP
 JM
 DD DESIGN MEETING

 02
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 JP
 JM
 FOR QS REVIEW


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DWG NO.

DD.00.02 | 03

PROJECT

2105

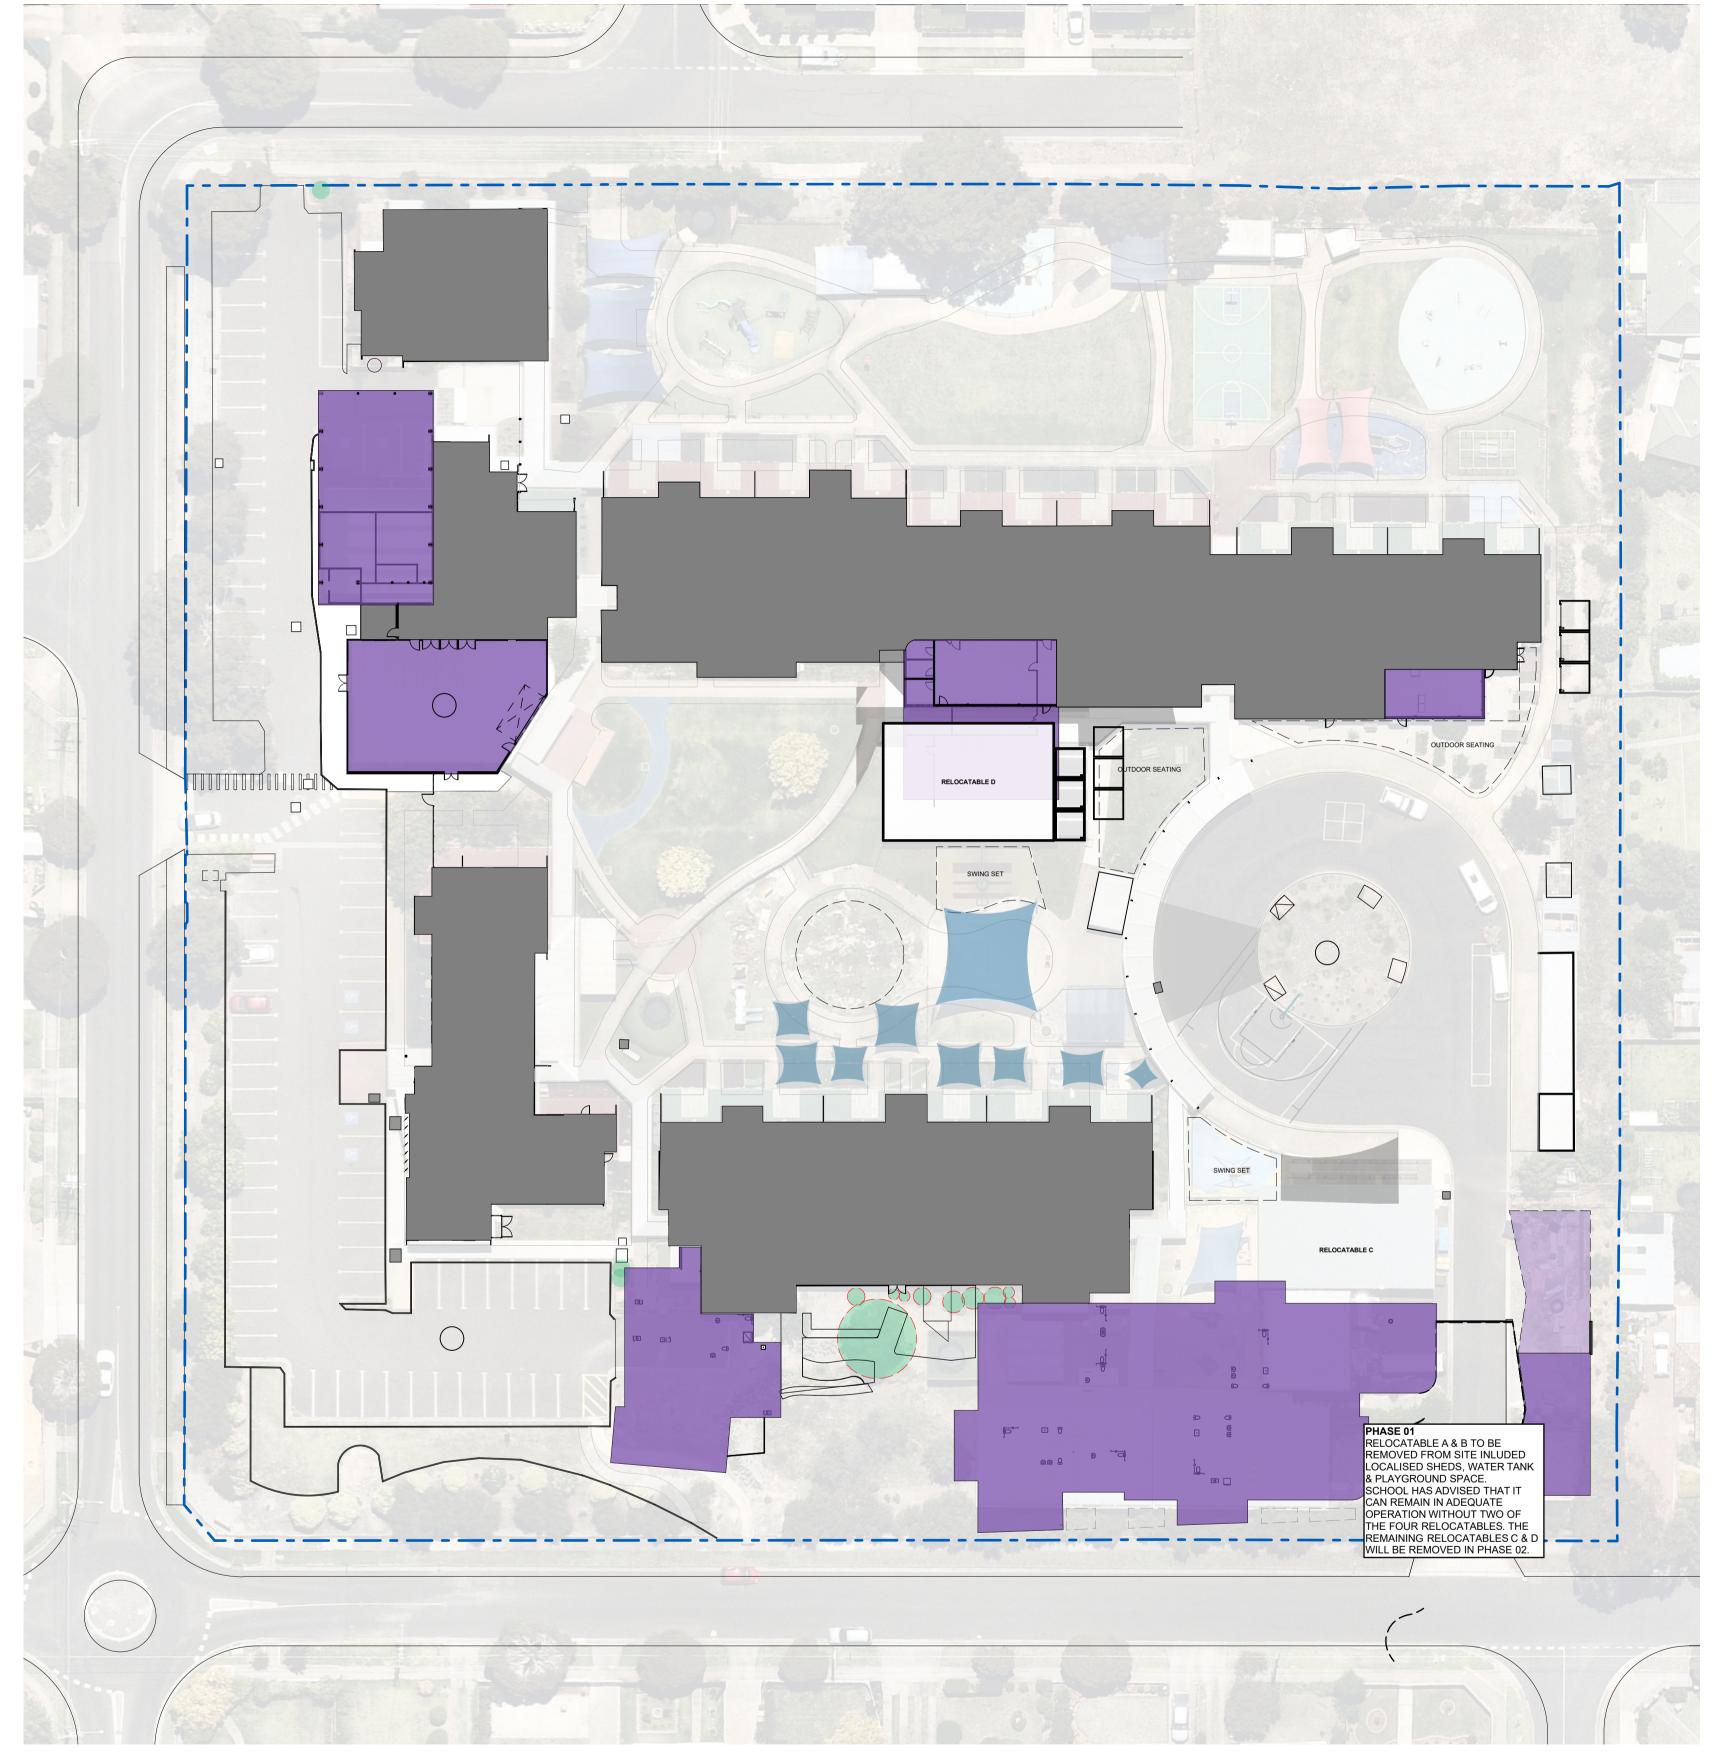

2	CARPARK (NORTH)
3	MULTI-PURPOSE BUILDING
4	MIDDLE LEARNING COMMUNITY BUILDING
5	SENIOR LEARNING COMMUNITY BUILDING
6	ADMINISTRATION BUILDING
7	CARPARK (SOUTH)
8	JUNIOR LEARNING COMMUNITY BUILDING

EXISTING BUS LOOP ROAD

SWIMMING POOL

LEGEND EXISTING SHADE SAIL EXISTING TREE EXISTING PATHWAY PROPOSED PATHWAY TREES & FLORA LOCATIONS SHOWN
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27/07/2021

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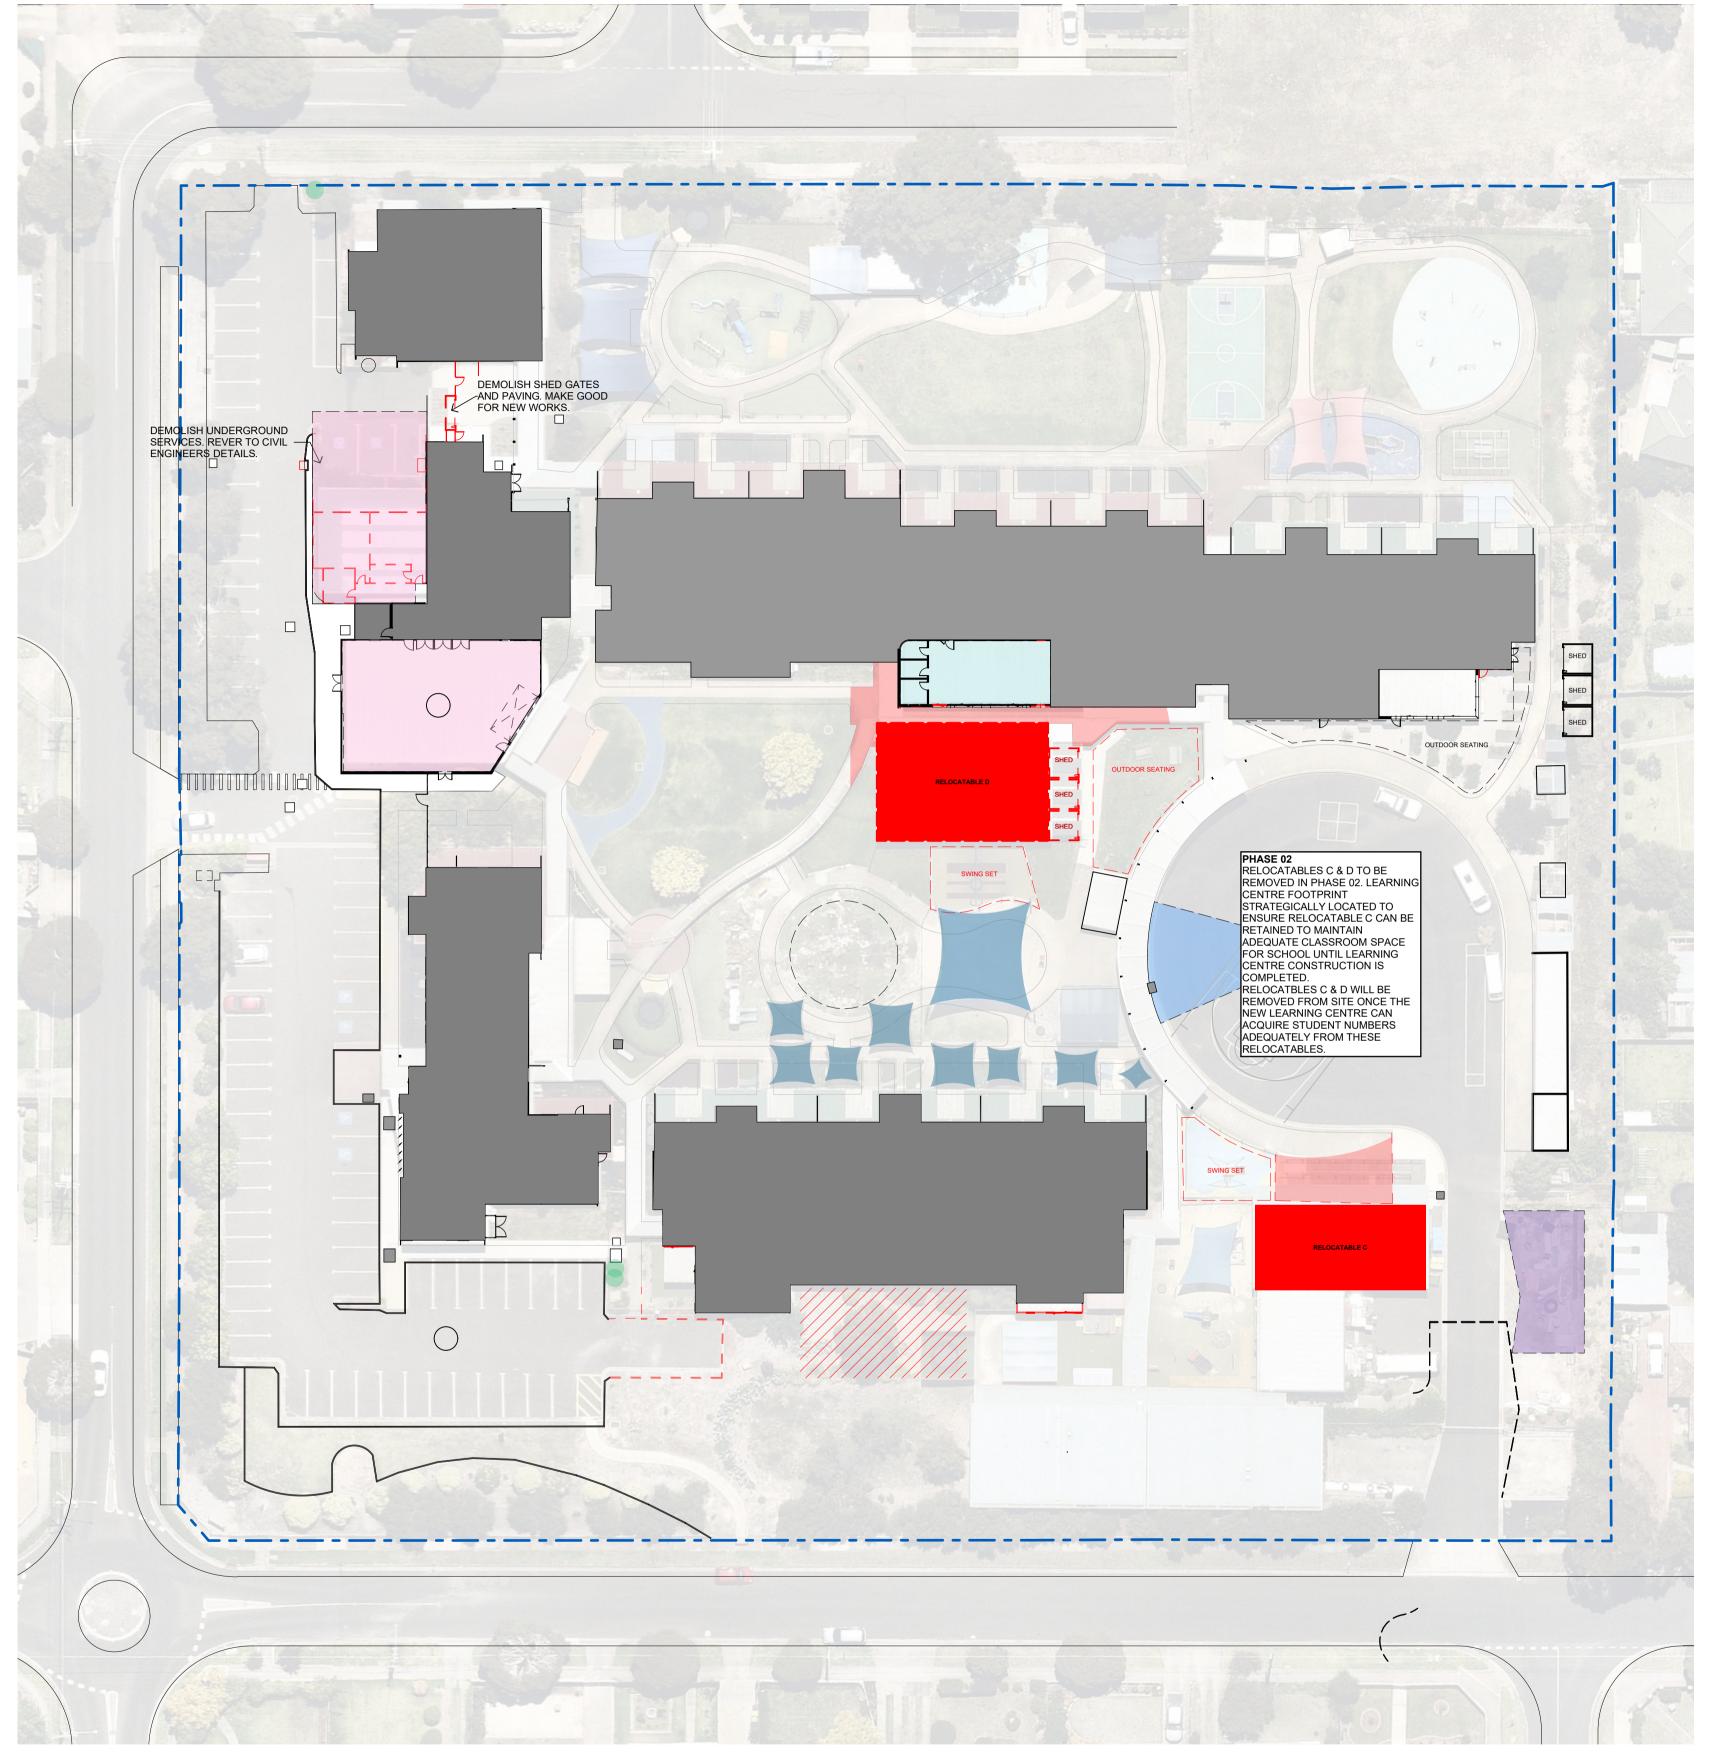
DD.00.03 | 03

PLOT DATE

PROJECT

2105

NOTES



1	SWIMMING POOL
2	CARPARK (NORTH)
3	MULTI-PURPOSE BUILDING
1	MIDDLE LEARNING COMMUNITY BUILDING
5	SENIOR LEARNING COMMUNITY BUILDING
6	ADMINISTRATION BUILDING
7	CARPARK (SOUTH)
3	JUNIOR LEARNING COMMUNITY BUILDING

EXISTING BUS LOOP ROAD

NOTES LEGEND EXISTING SHADE SAIL EXISTING TREE EXISTING PATHWAY PROPOSED PATHWAY TREES & FLORA LOCATIONS SHOWN
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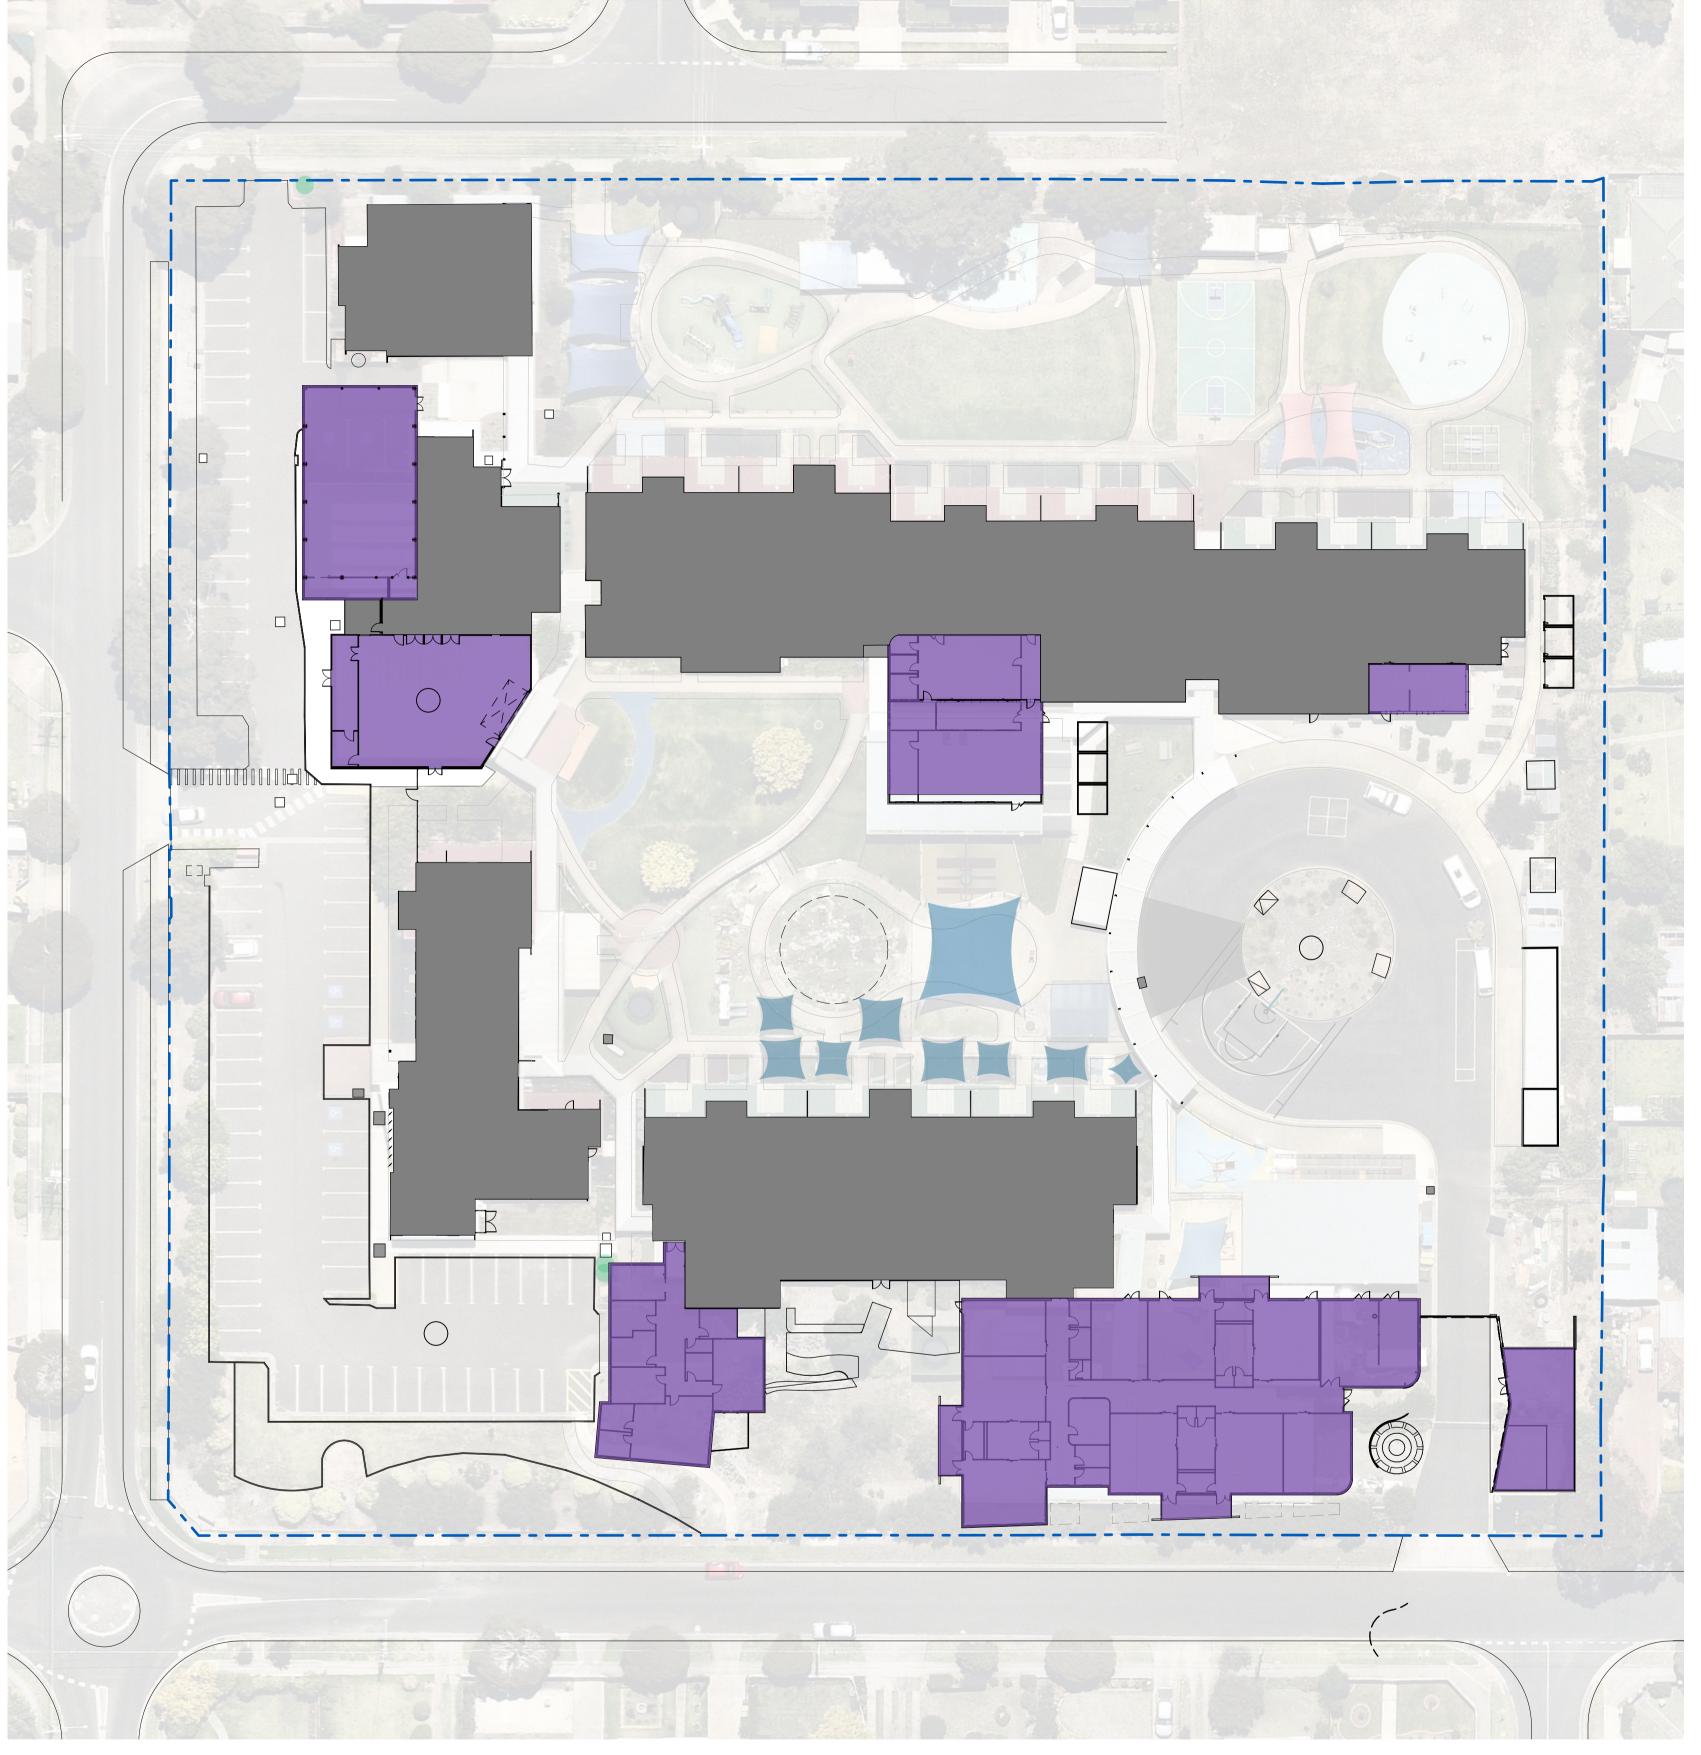
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CAD FILE 2105 BVS Stage 2 - DD

Barwon Valley School - Stage 2

Construction & Decanting: Phase SCALE 1:400@ A1 DRAWN CHECKED JM

27/07/2021 PLOT DATE PROJECT DWG NO. 2105 DD.00.04 | 03



SWIMMING POOL

CARPARK (NORTH)

MULTI-PURPOSE BUILDING

MIDDLE LEARNING COMMUNITY BUILDING

SENIOR LEARNING COMMUNITY BUILDING

ADMINISTRATION BUILDING

CARPARK (SOUTH)

JUNIOR LEARNING COMMUNITY BUILDING

EXISTING BUS LOOP ROAD

PROPOSED NEW INFRASTRUCTURE

PERFORMING ARTS BUILDING
STEAM HUB
THERAPY HUB
LEARNING CENTRE
BUS SHELTER EXTENSION (DESIGN TBC)

 REV
 DATE
 BY
 CH
 DESCRIPTION

 01
 14/07/2021
 JP
 JM
 DD DESIGN MEETING

 02
 16/07/2021
 JP
 JM
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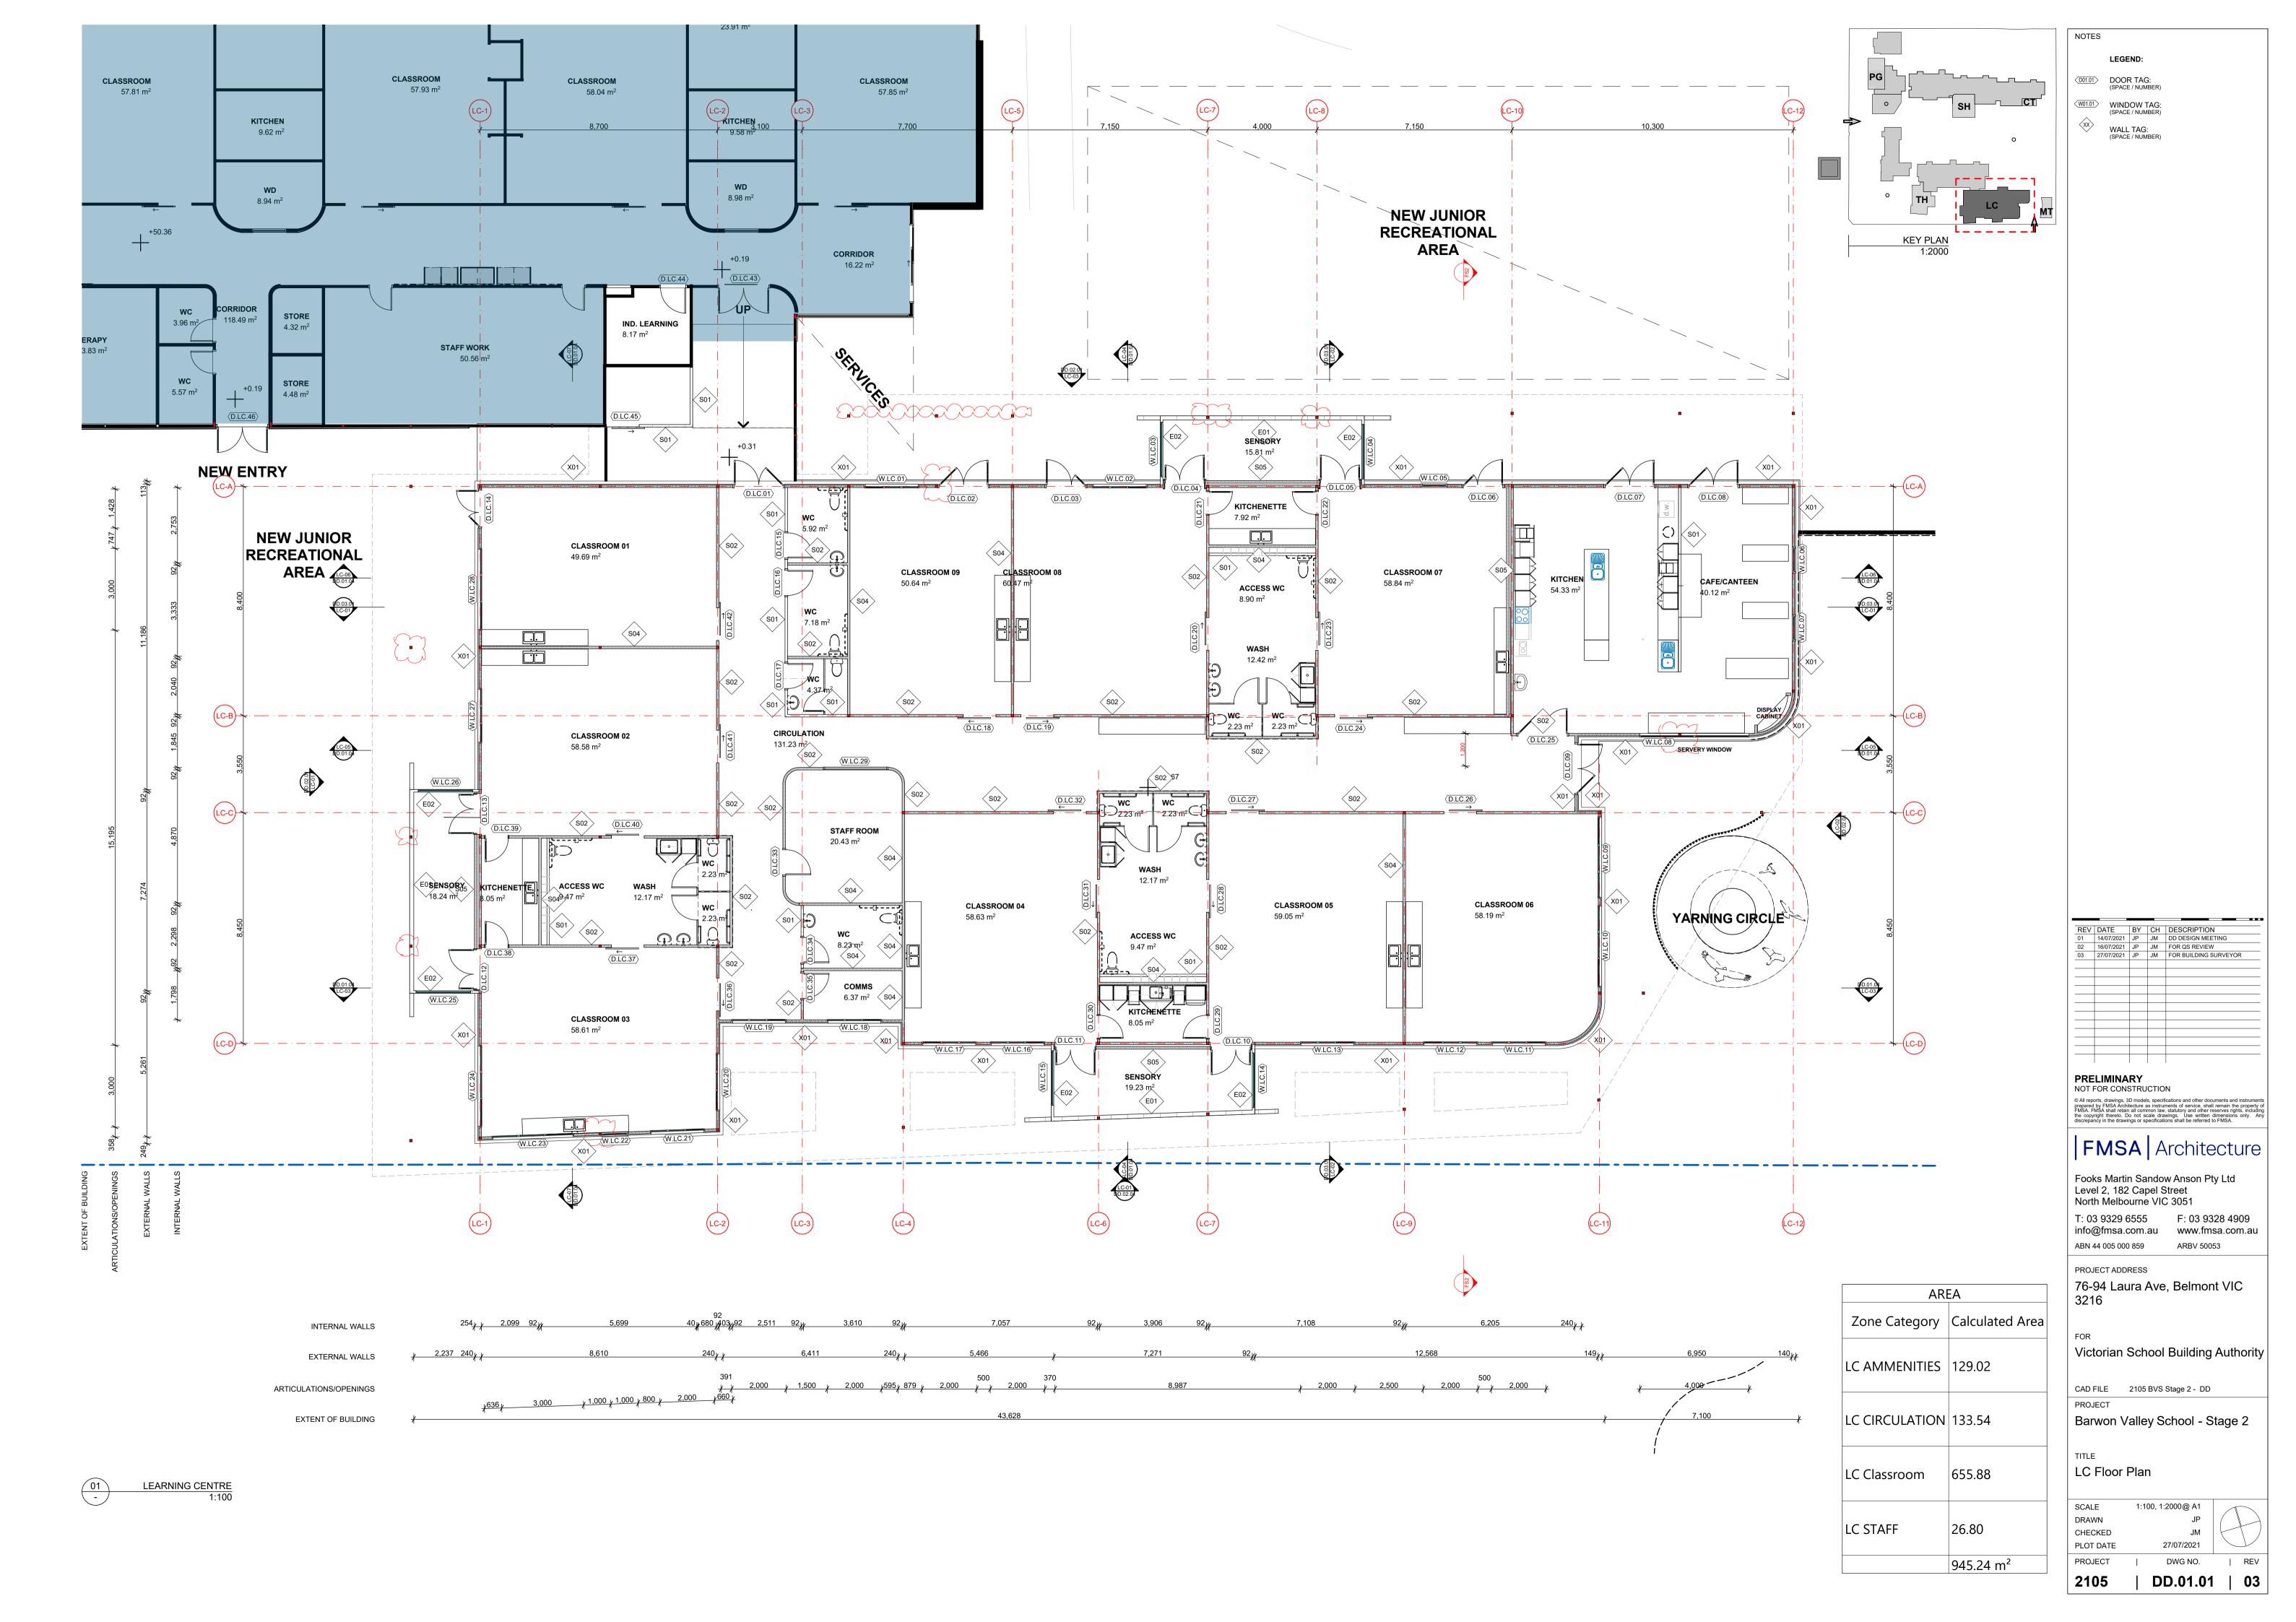
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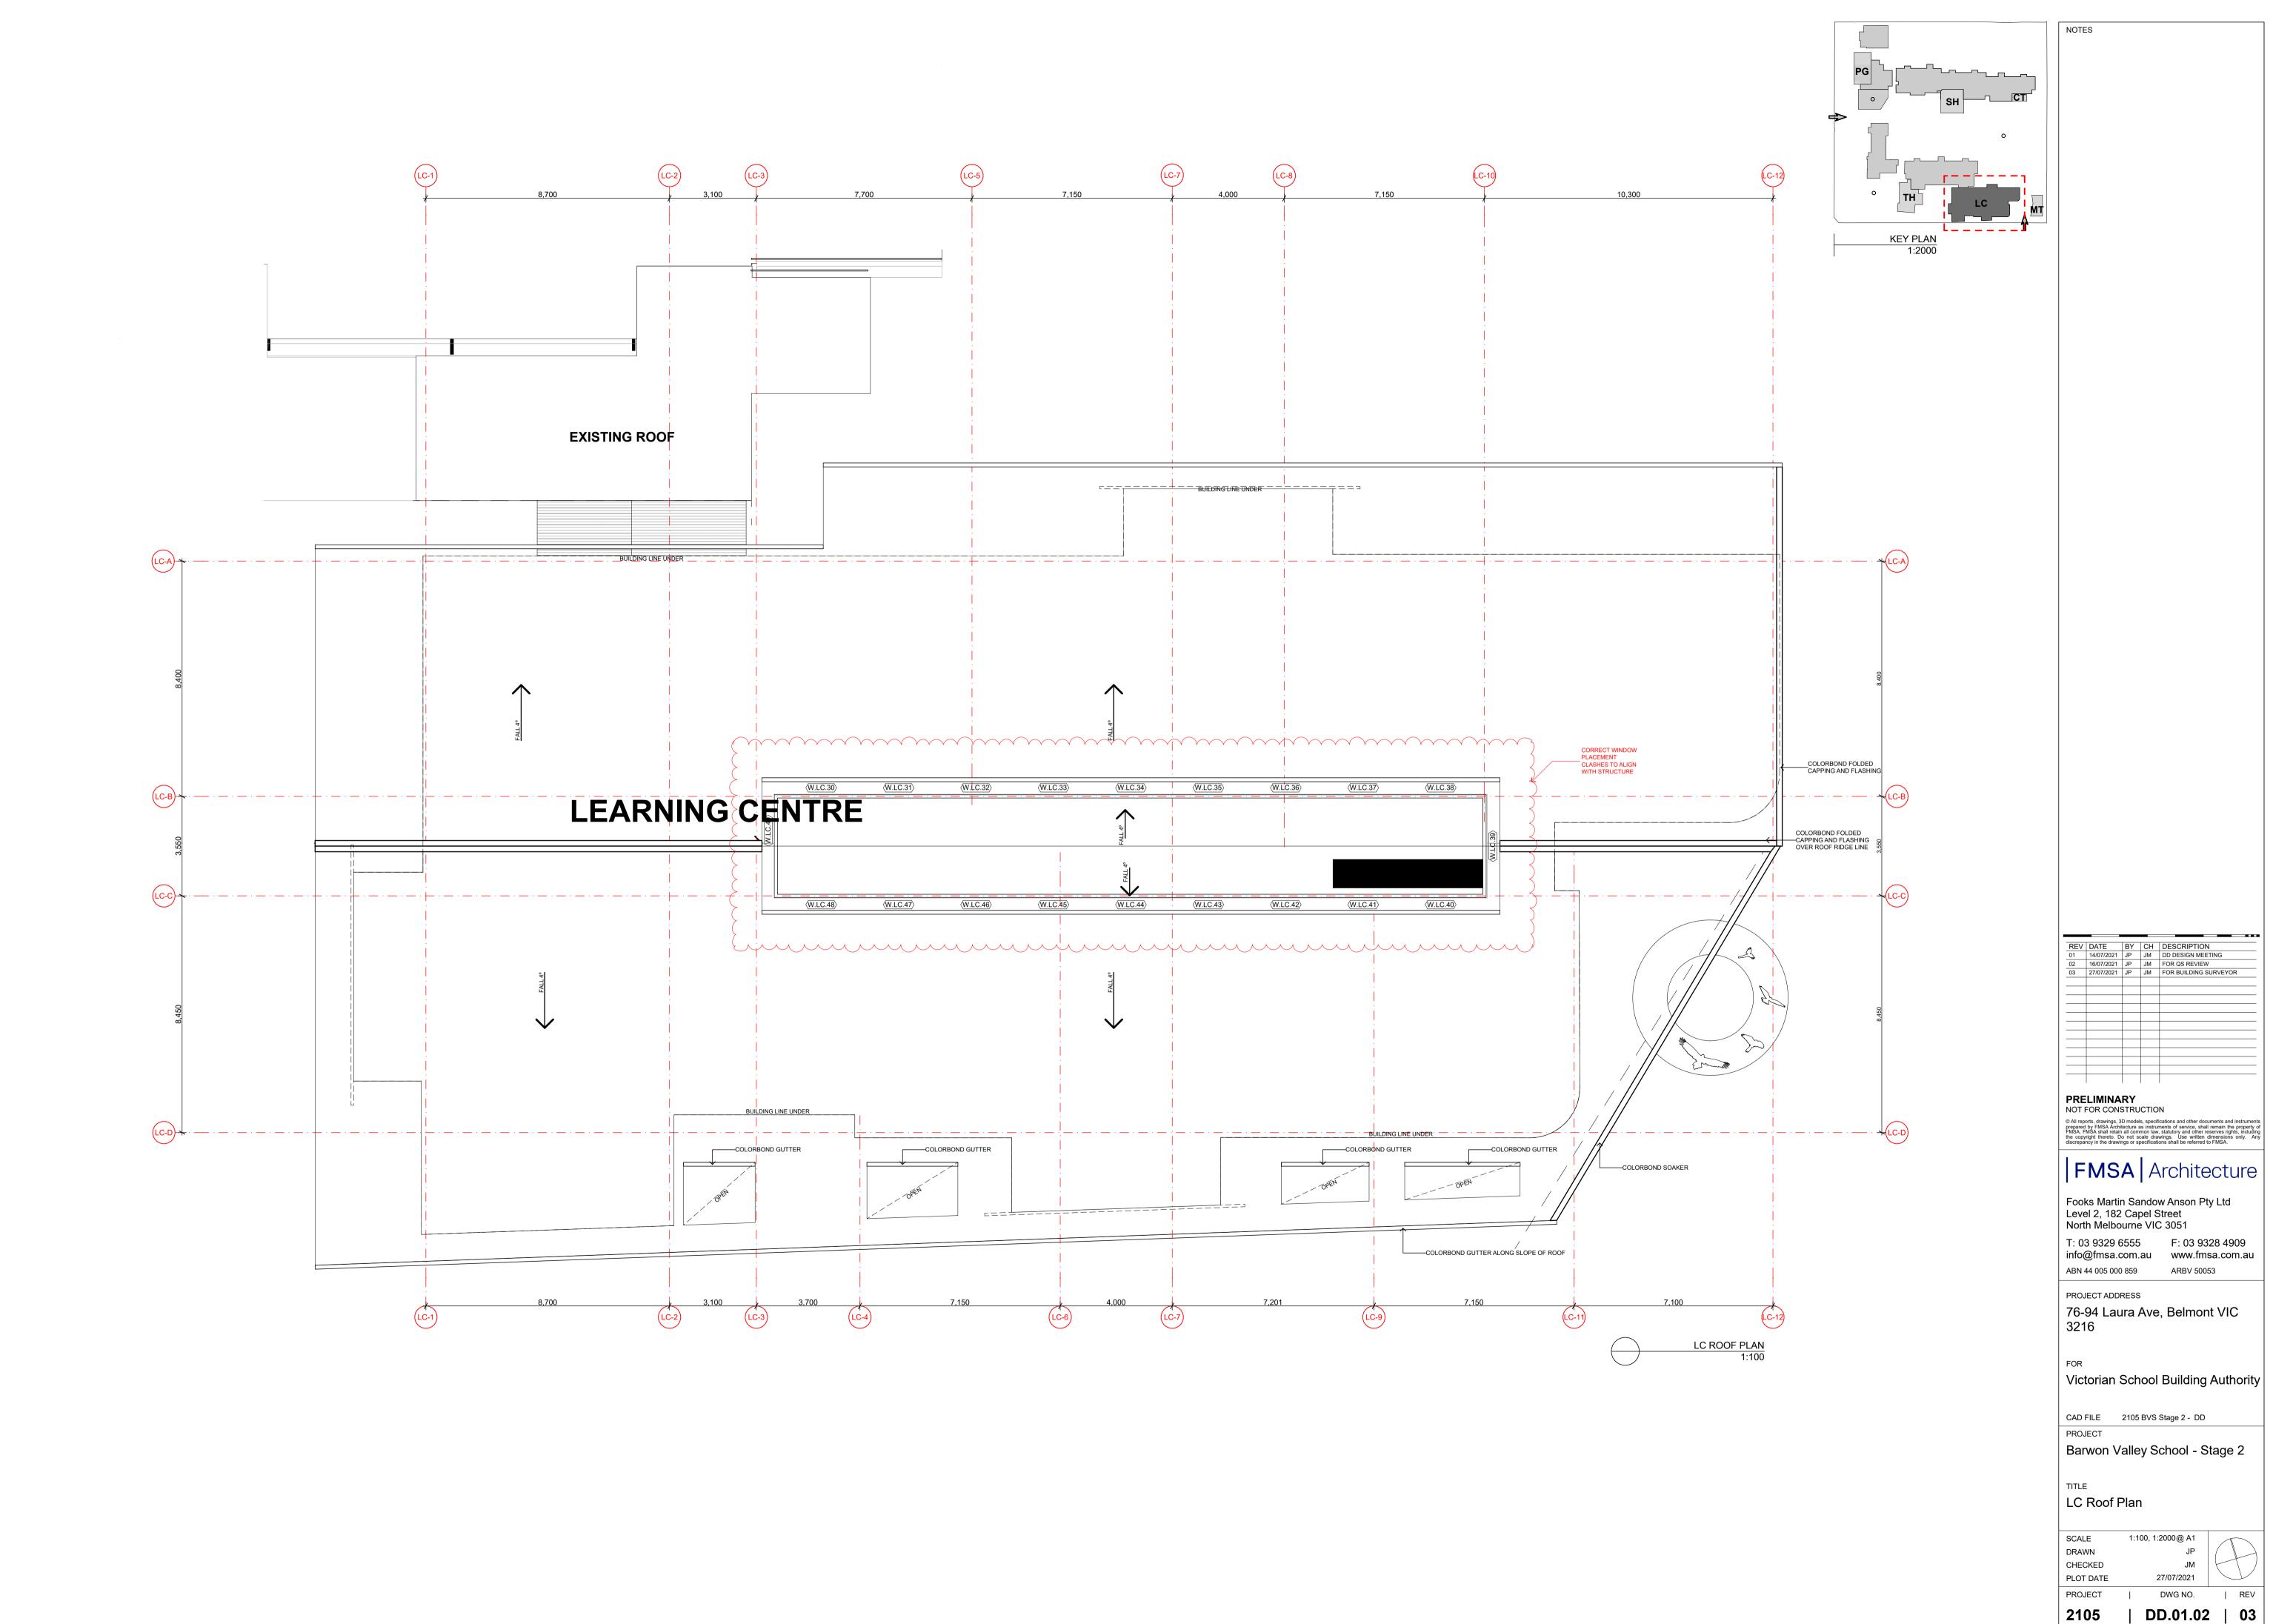
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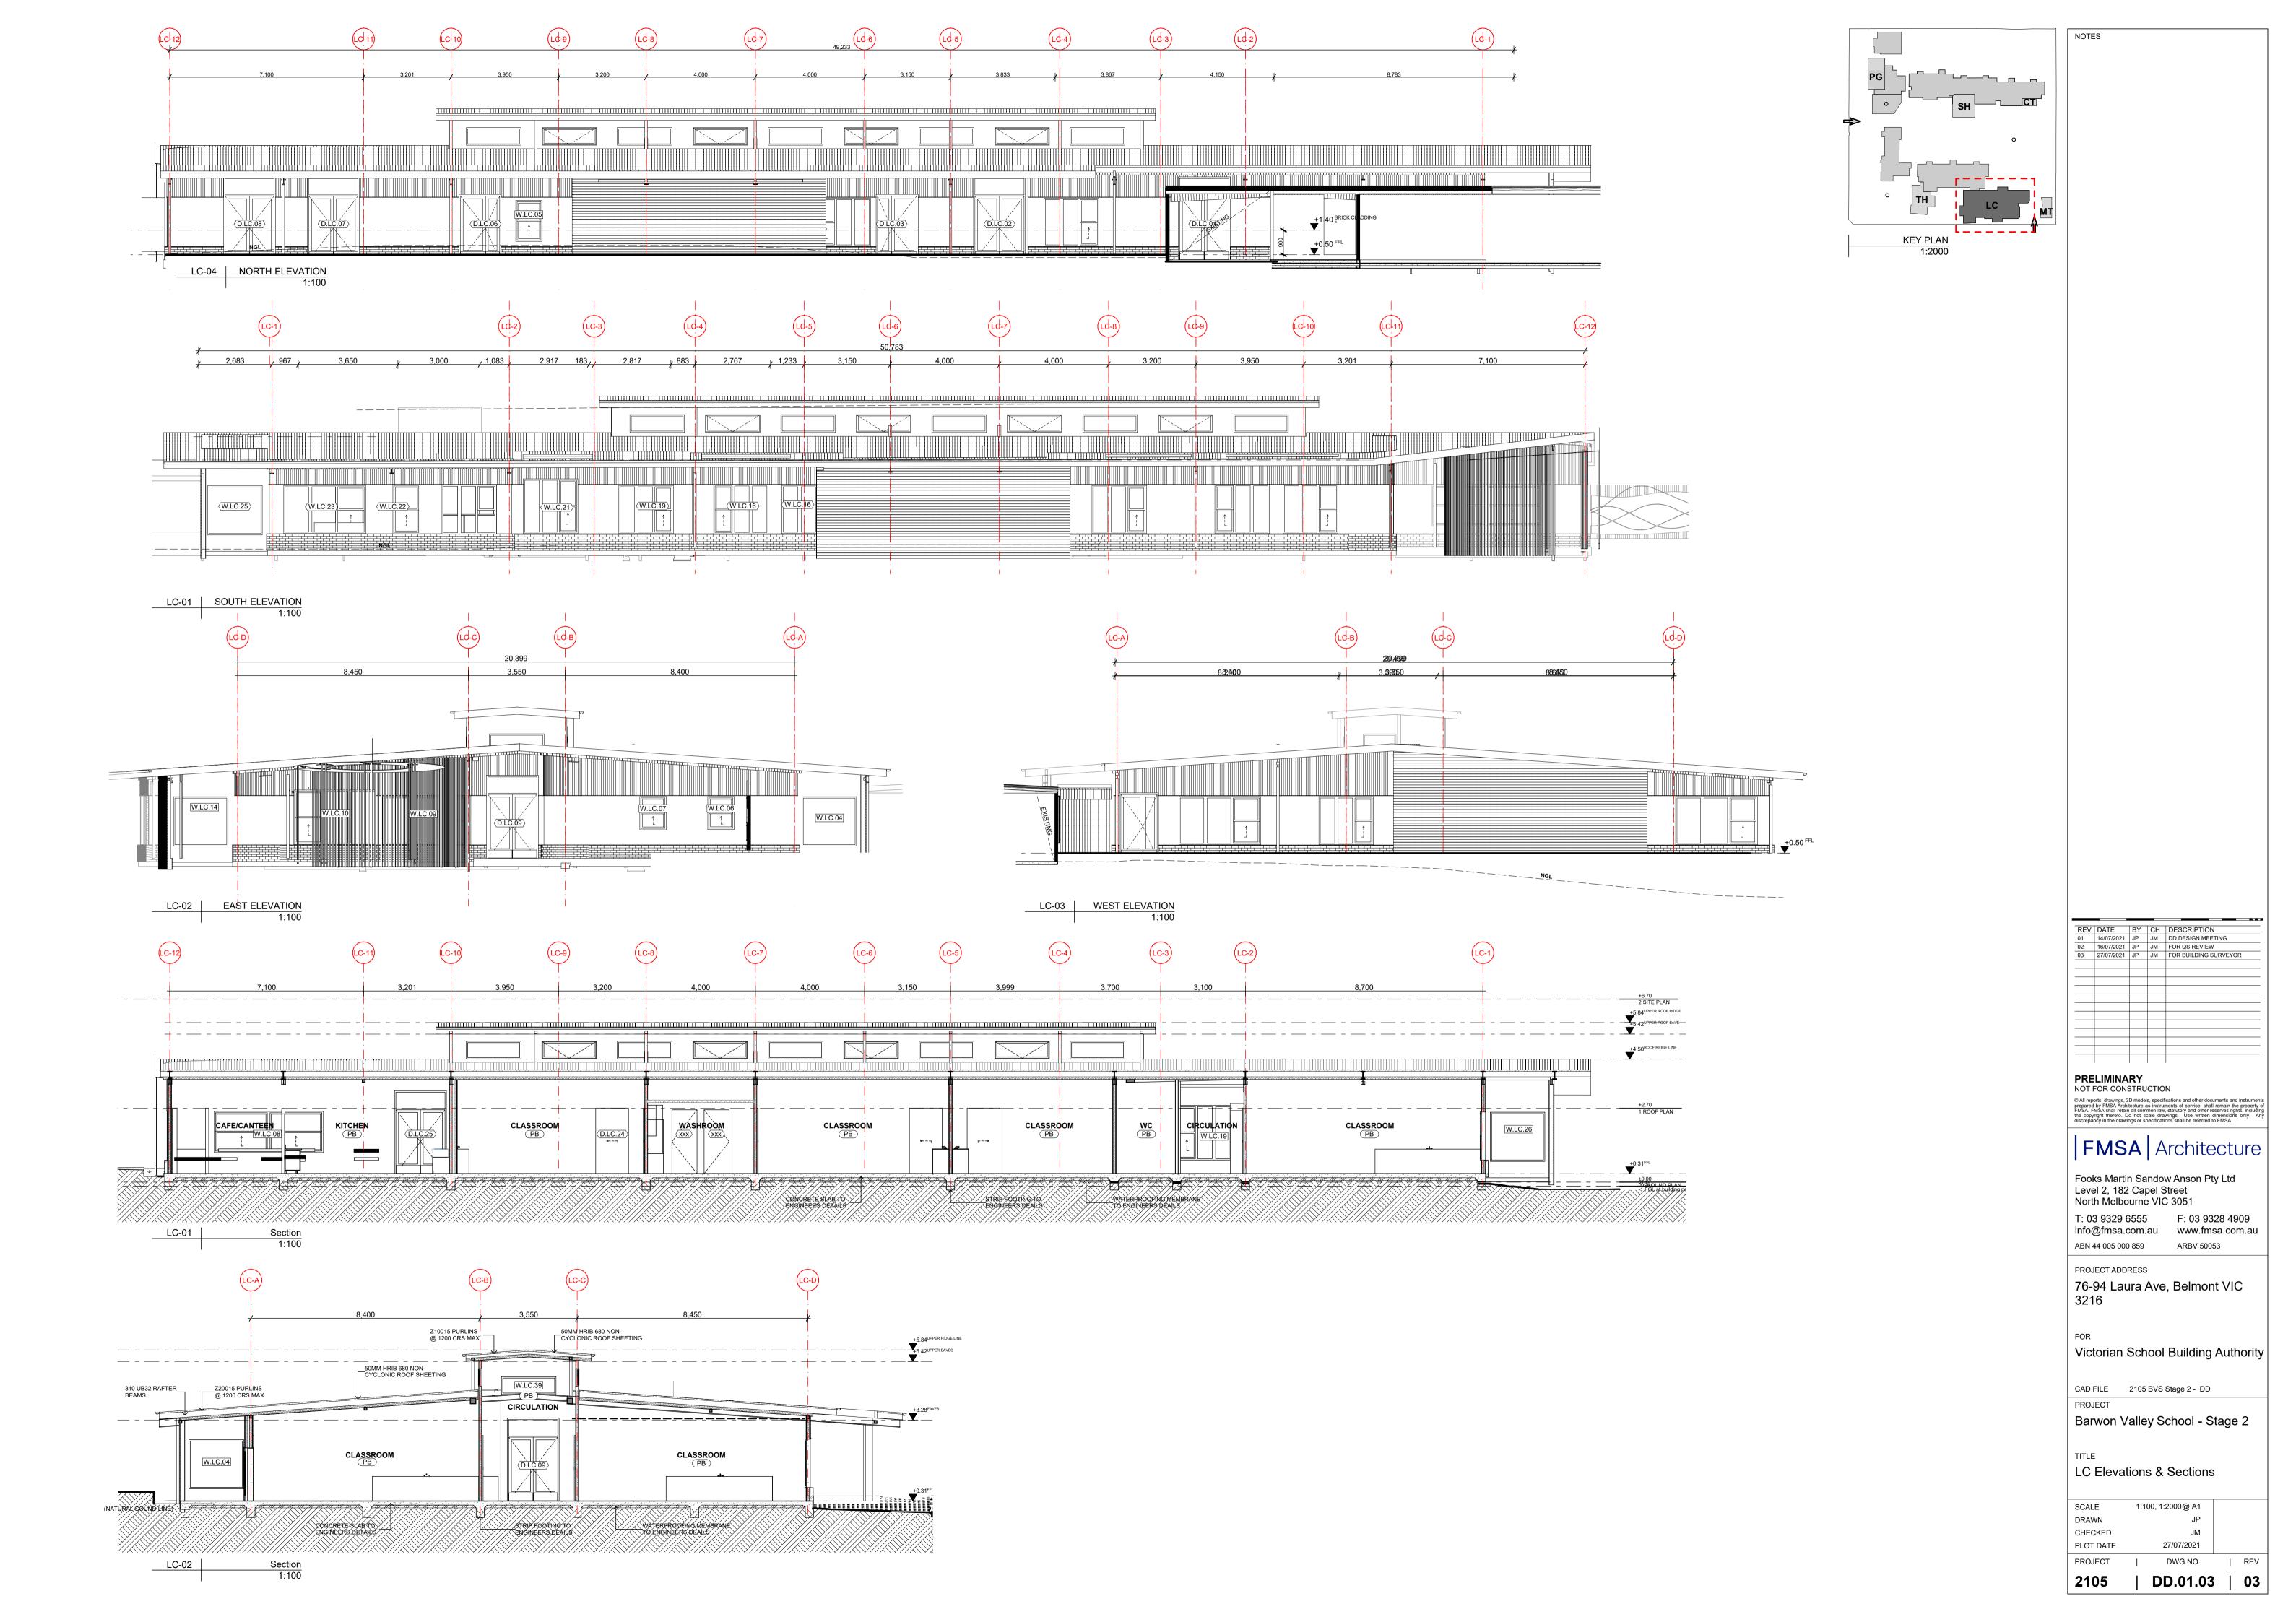
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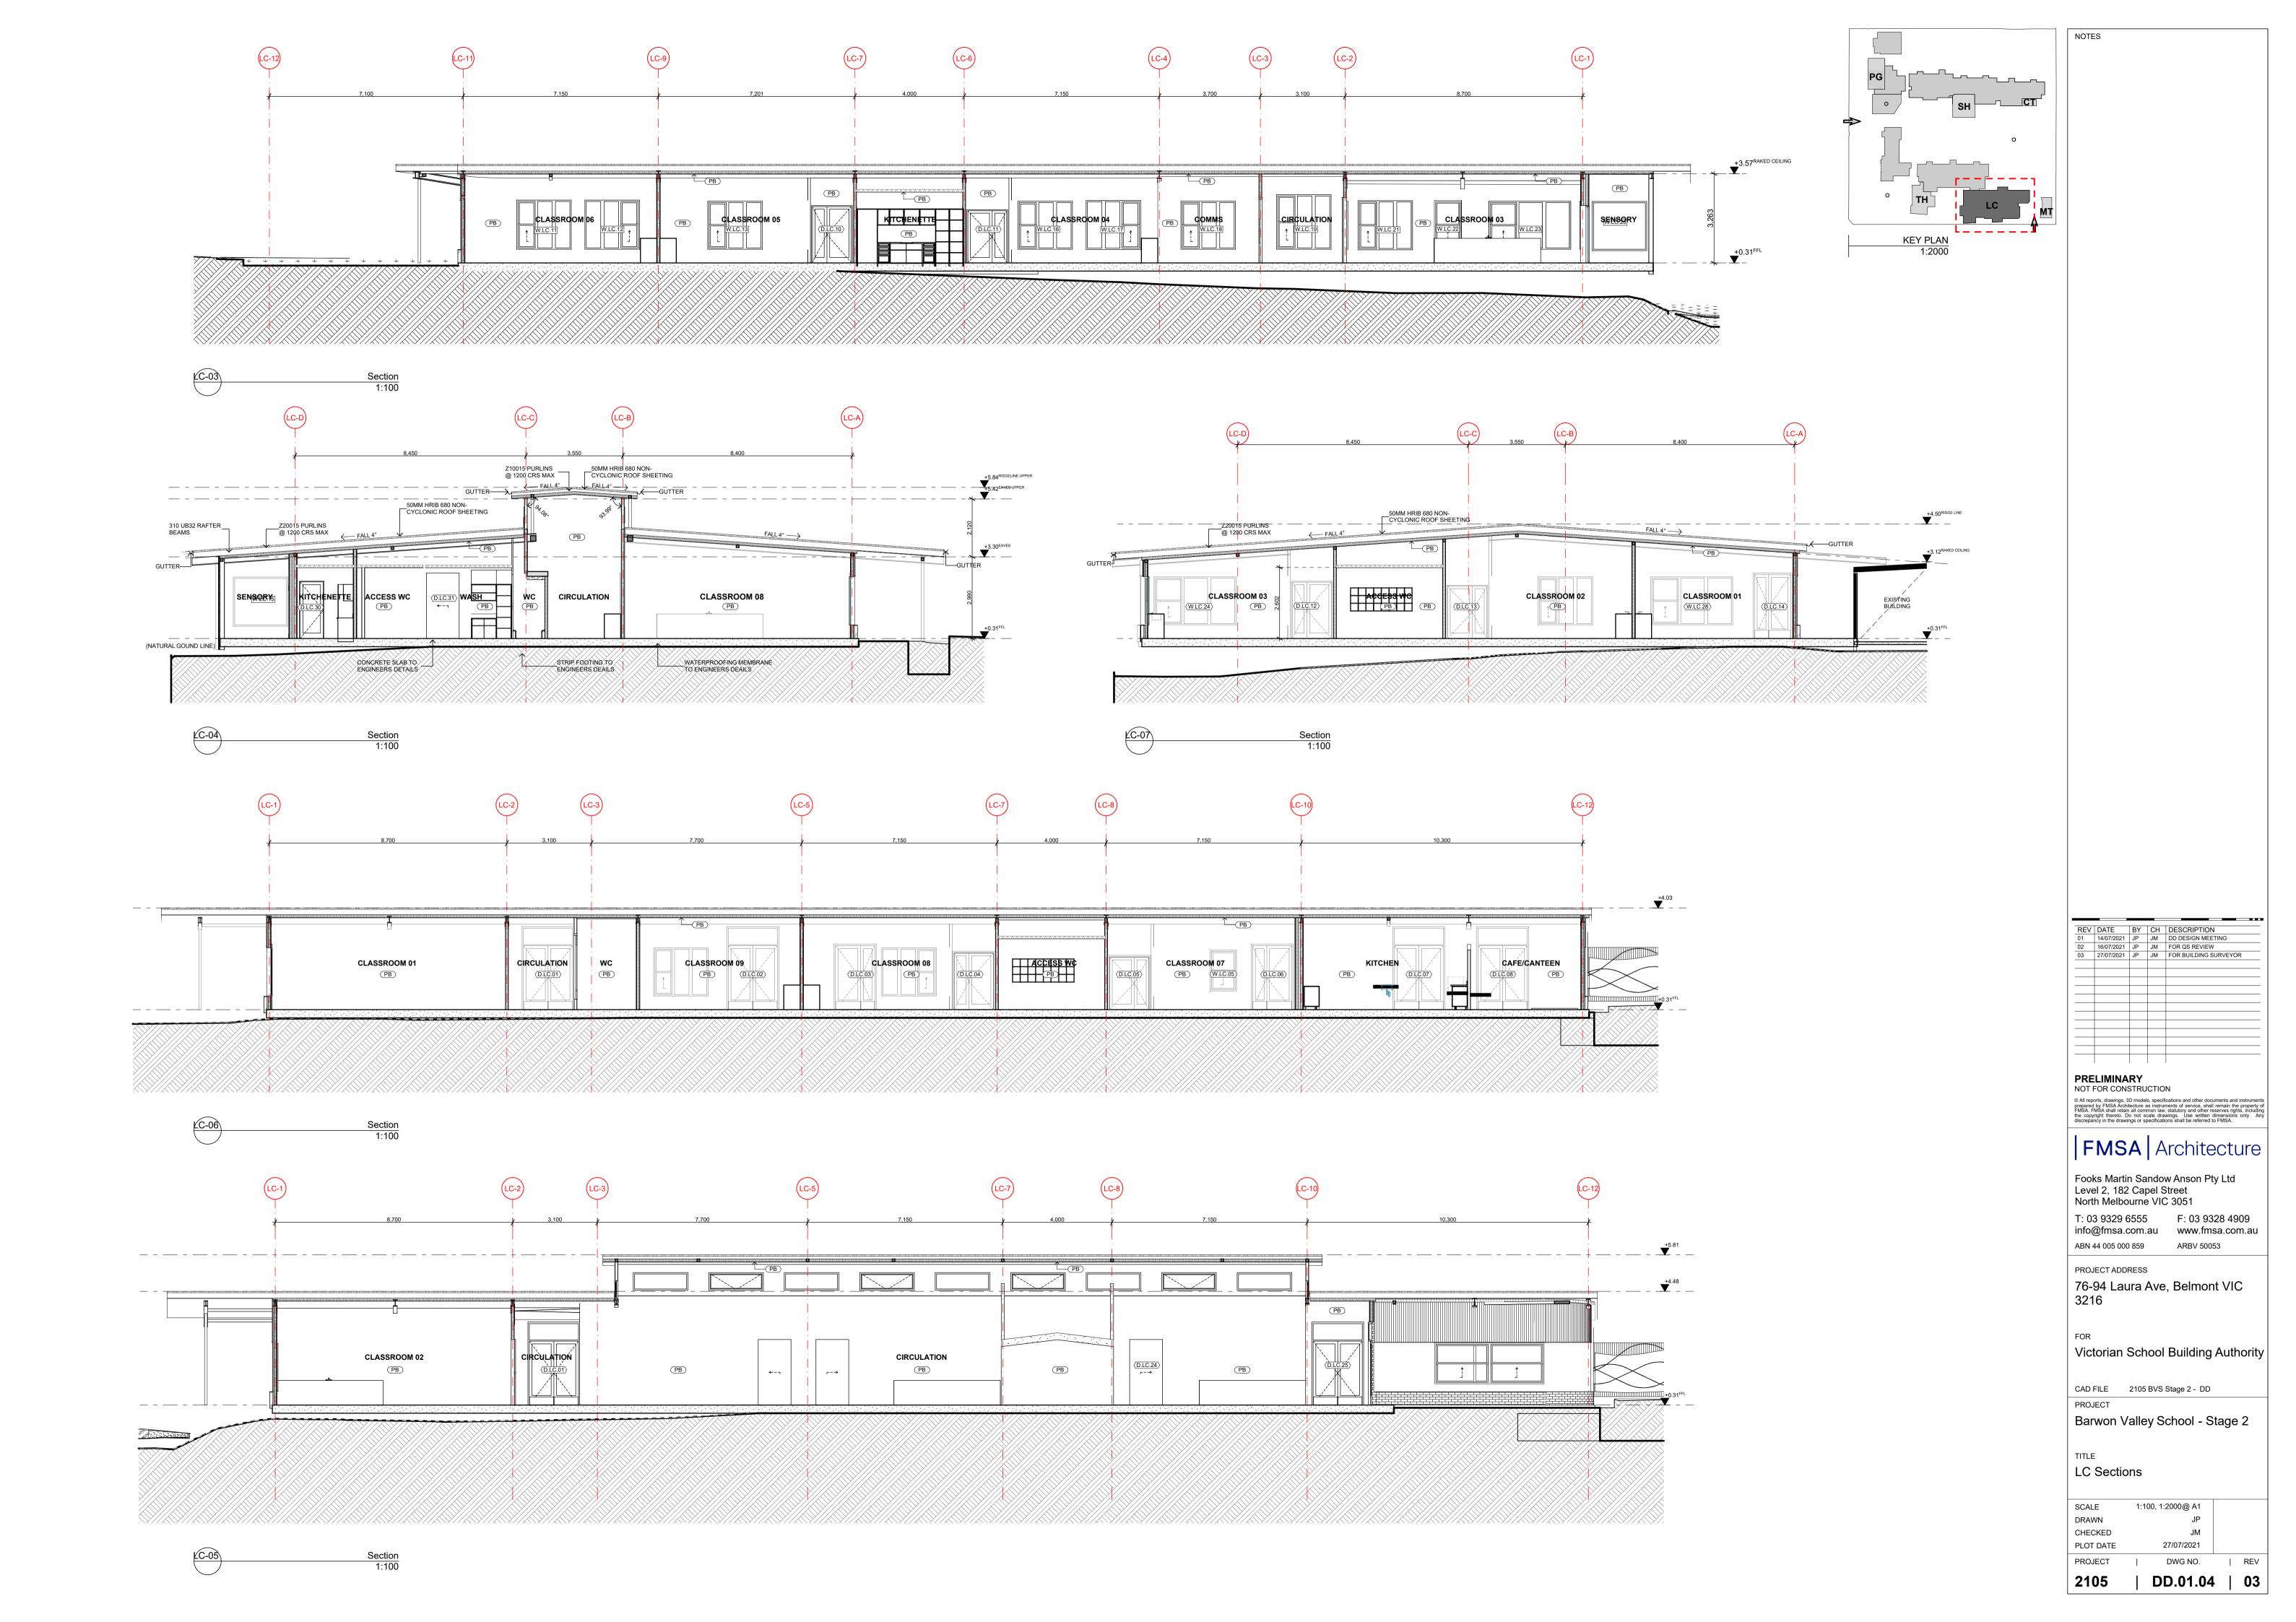
PROPOSED PATHWAY


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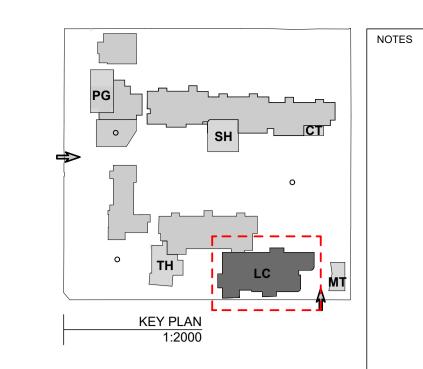










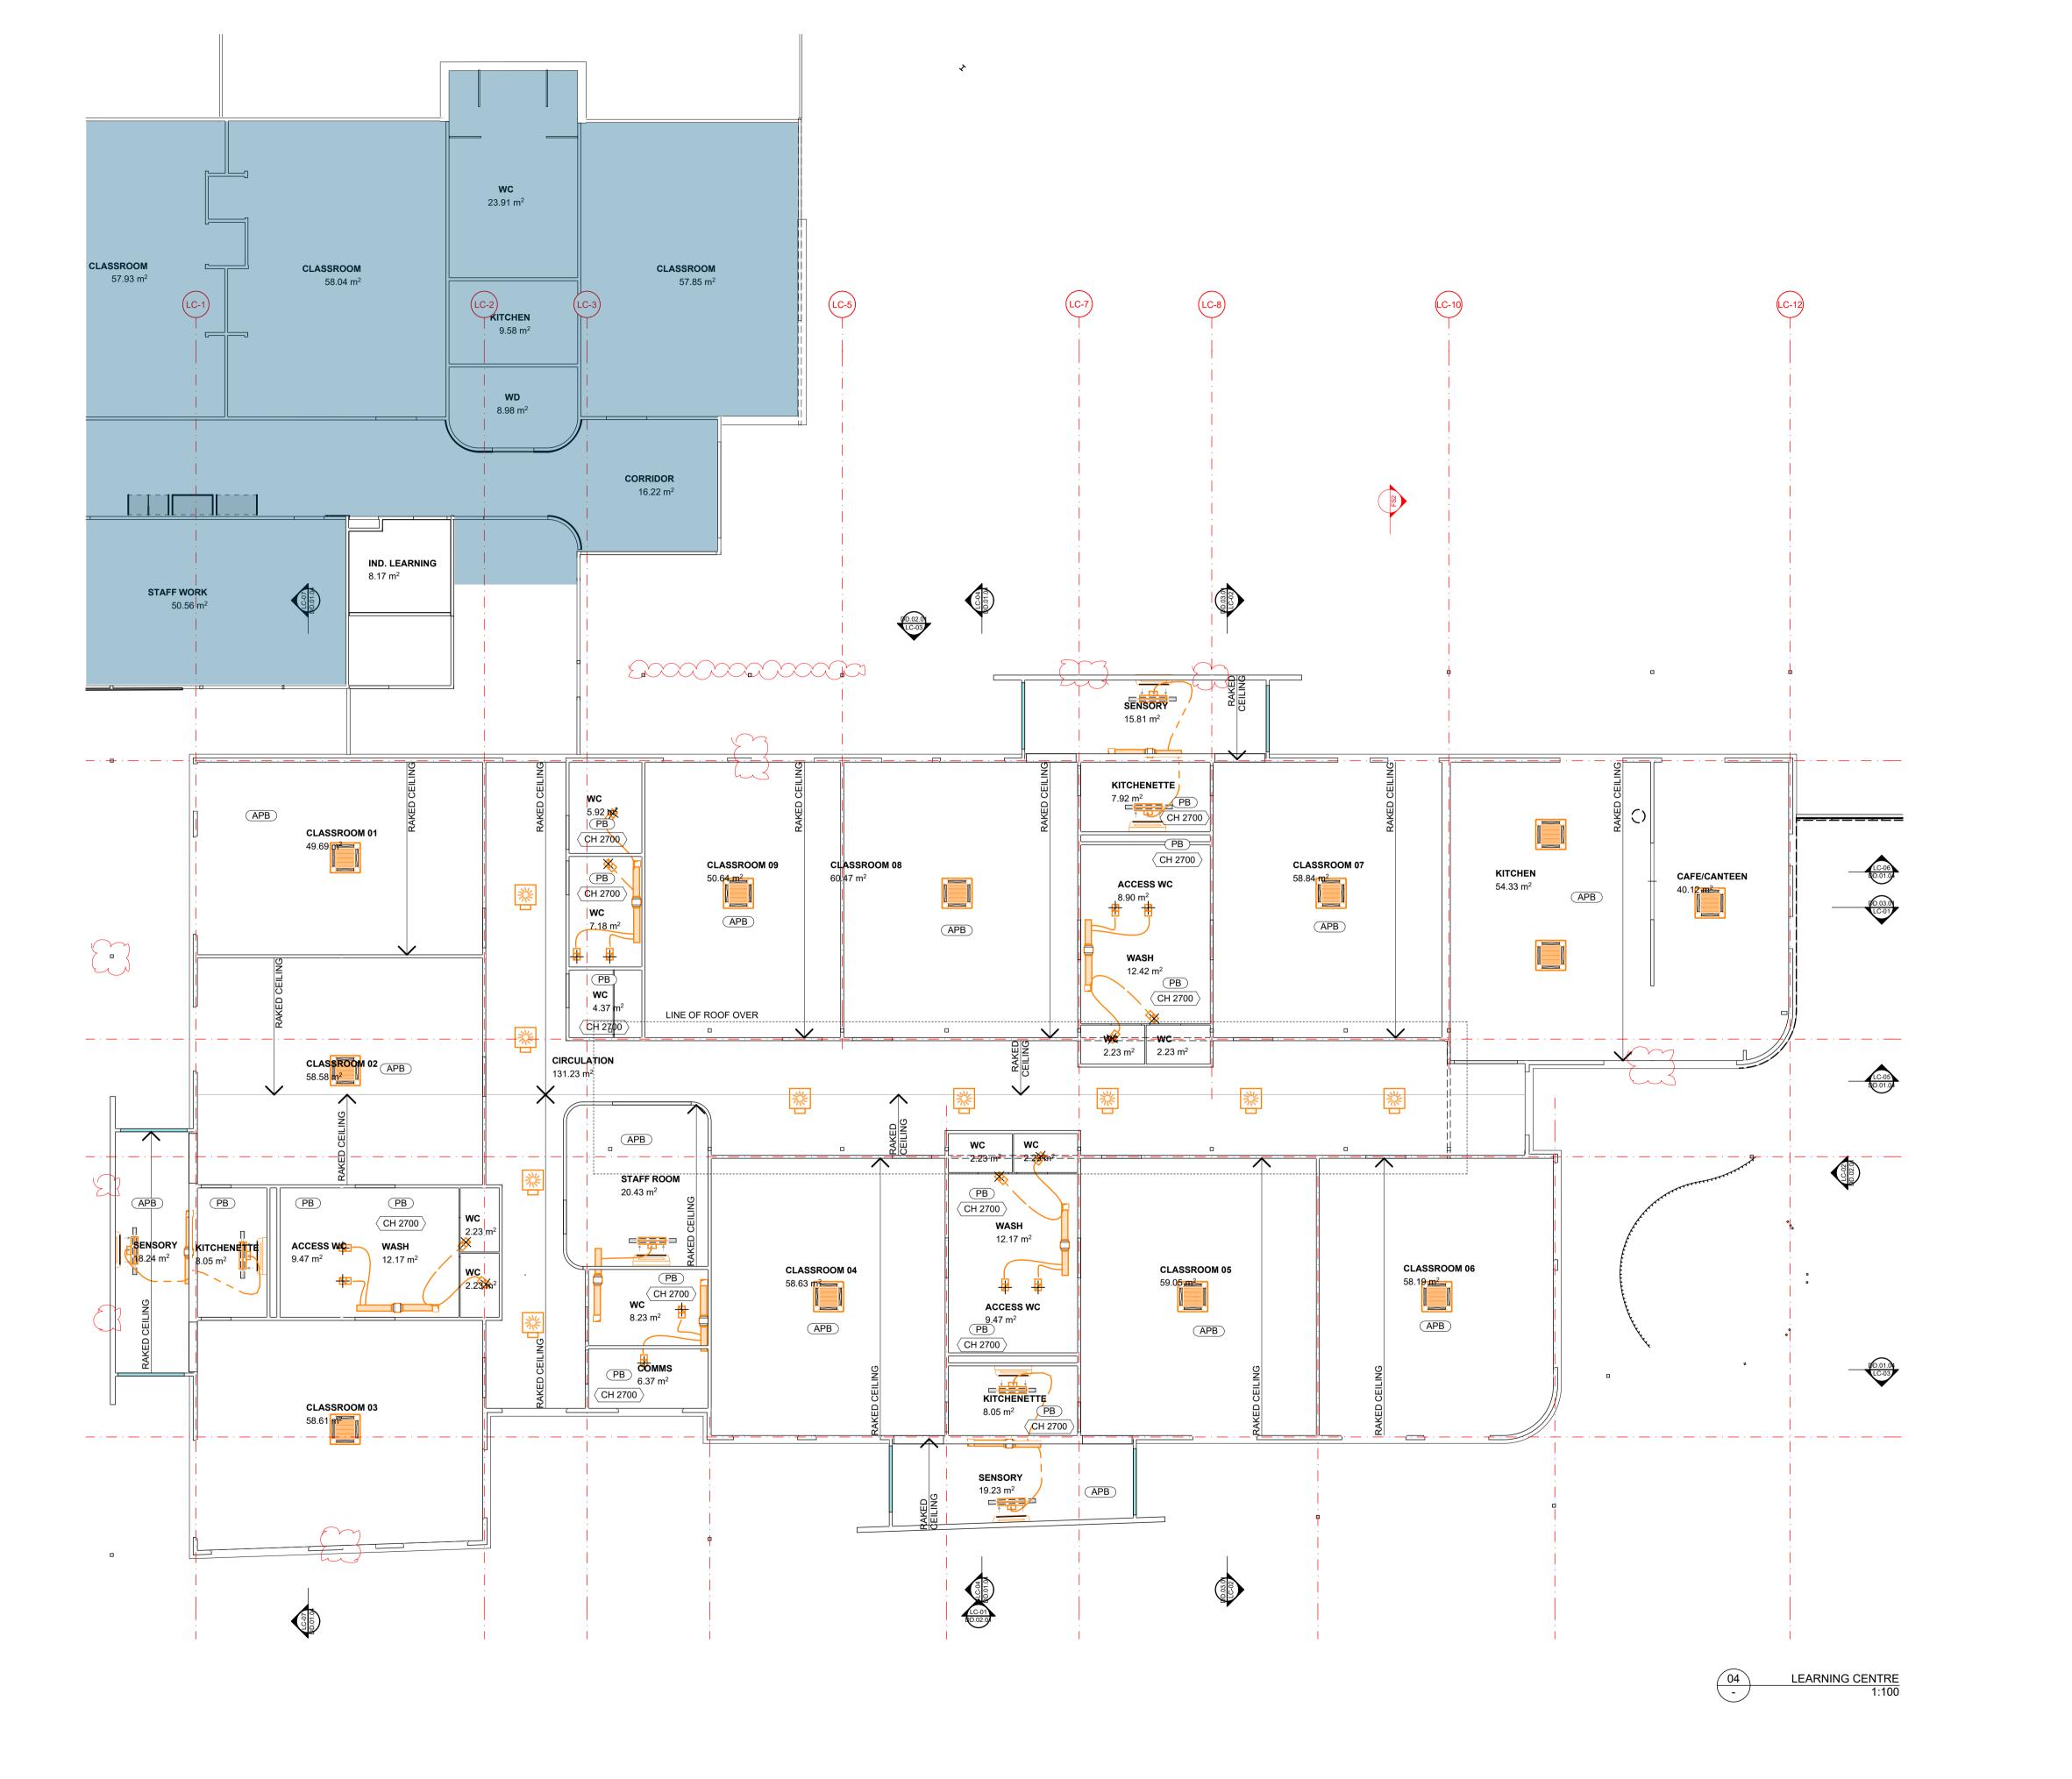

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 FOR QS REVIEW

 03
 21/07/2021
 JP
 JM
 FOR ENGINEERS COORDINATION

 04
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PROJECT ADDRESS

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Victorian School Building Authority


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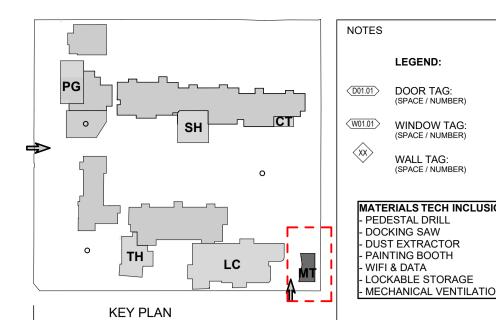
Barwon Valley School - Stage 2

LC Reflected Ceiling Plan

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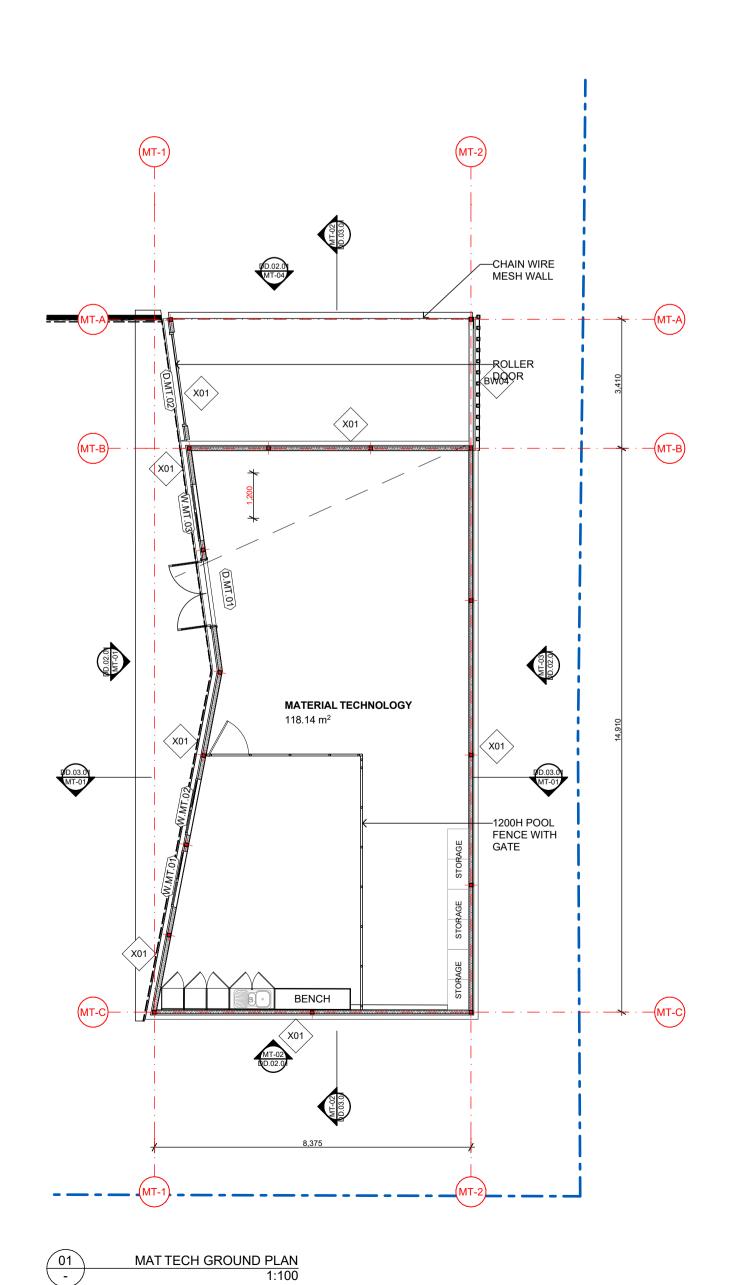






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MATERIALS TECH INCLUSIONS
- PEDESTAL DRILL
- DOCKING SAW
- DUST EXTRACTOR
- PAINTING BOOTH

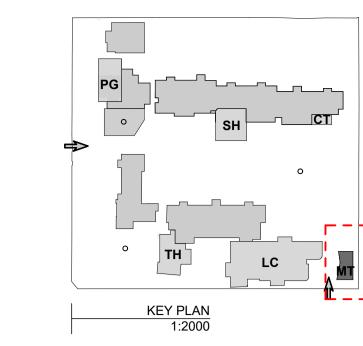- FAINTING BOOTH - WIFI & DATA - LOCKABLE STORAGE - MECHANICAL VENTILATION





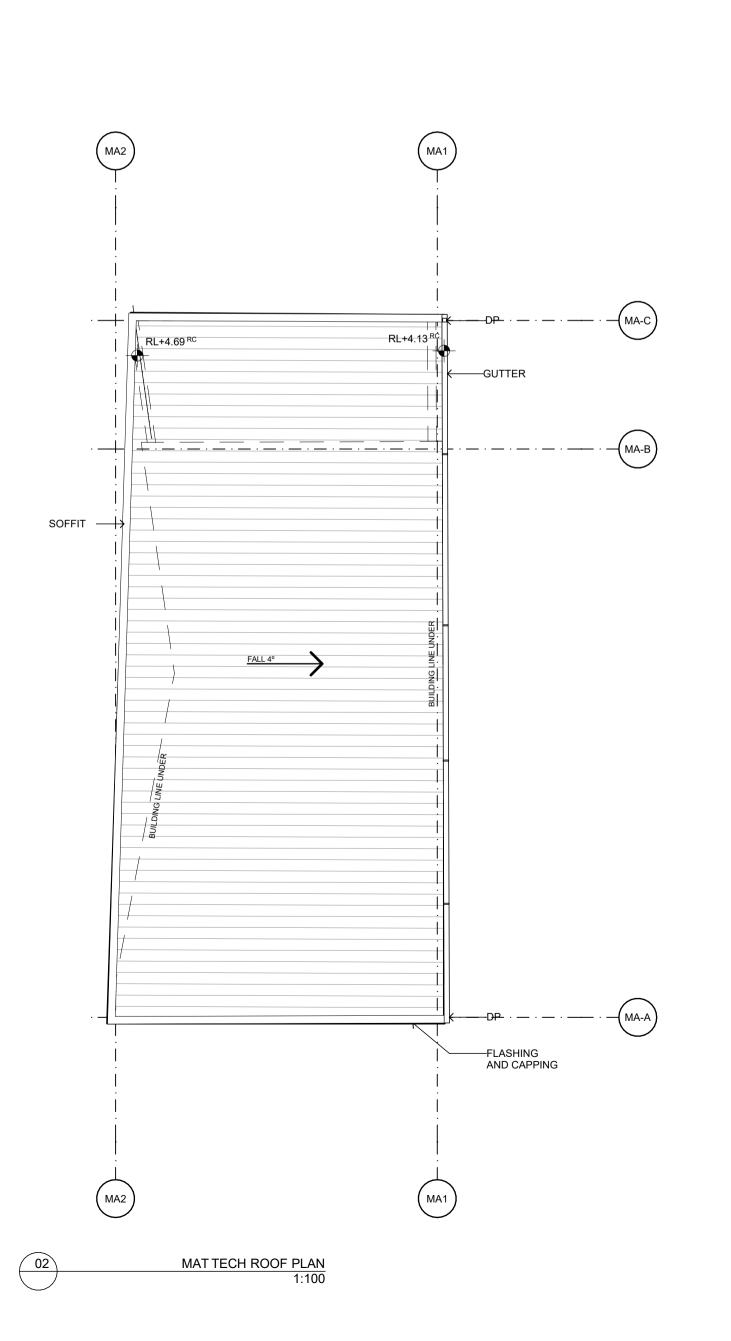
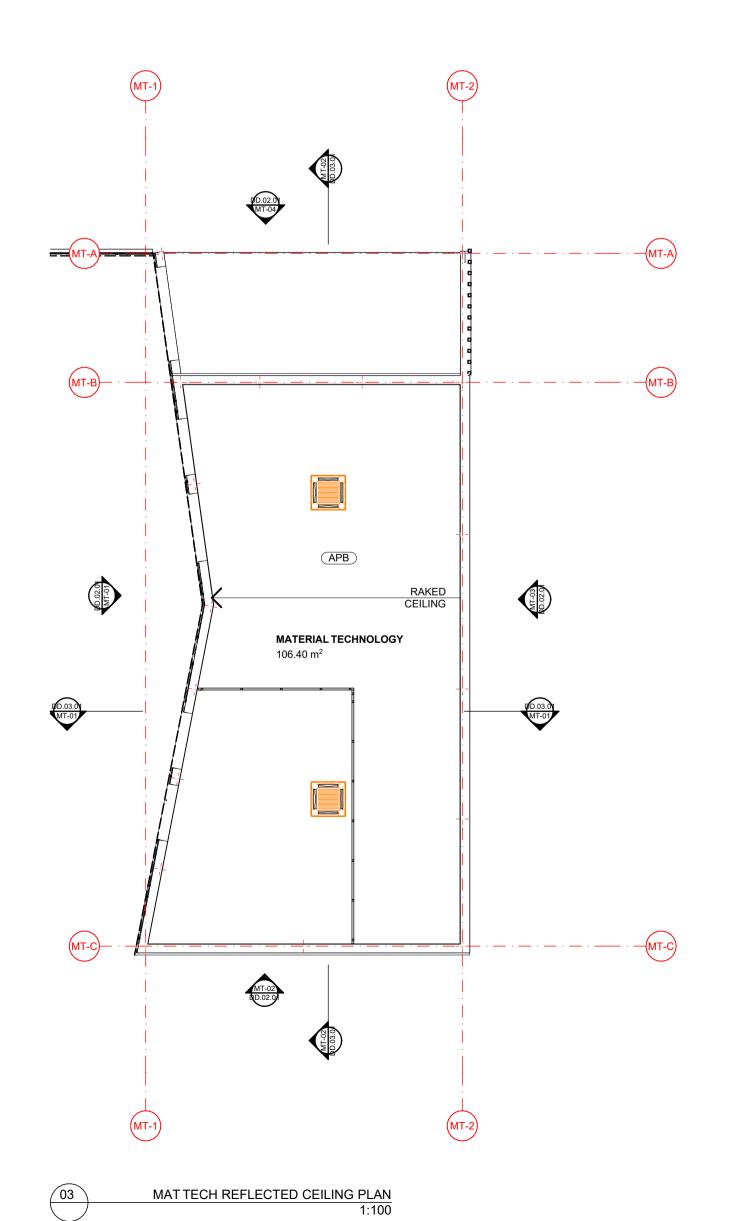
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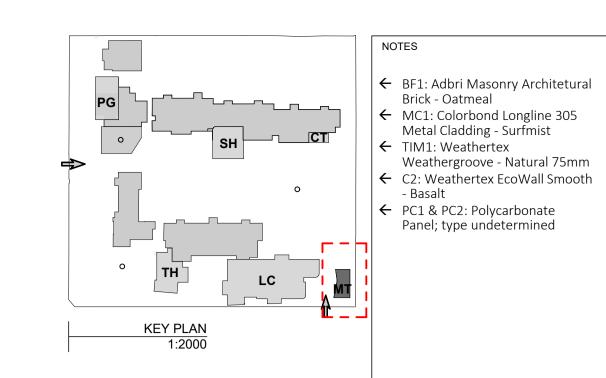
Victorian School Building Authority


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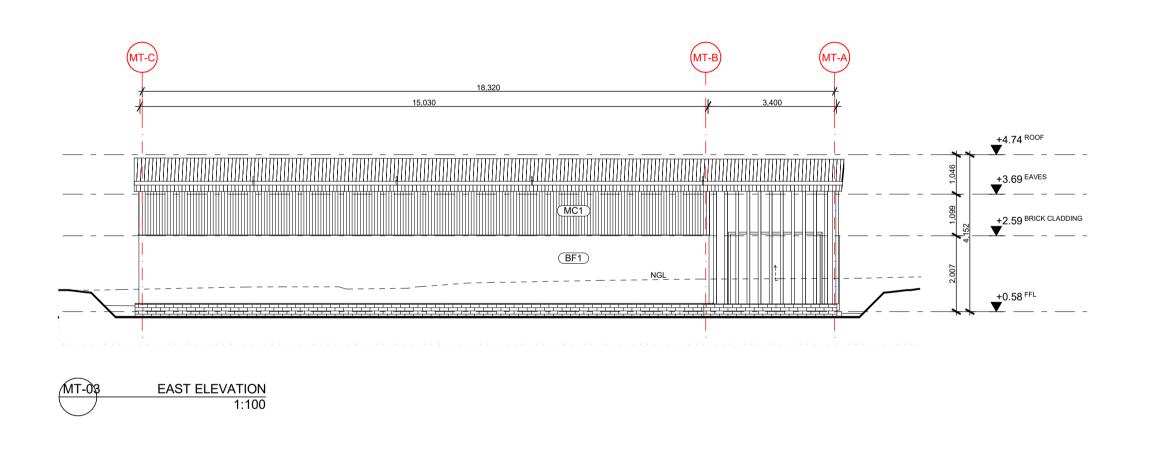
Barwon Valley School - Stage 2


MT Plans


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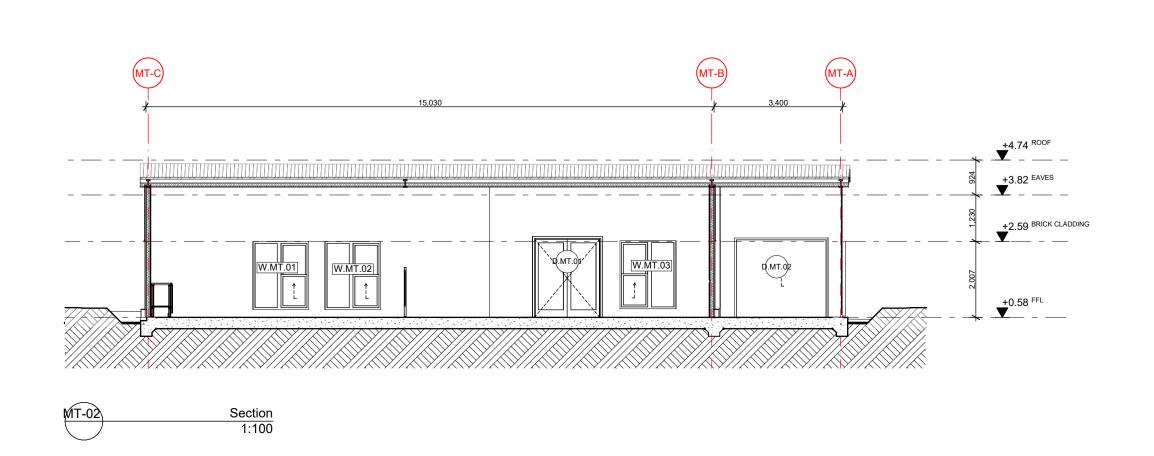







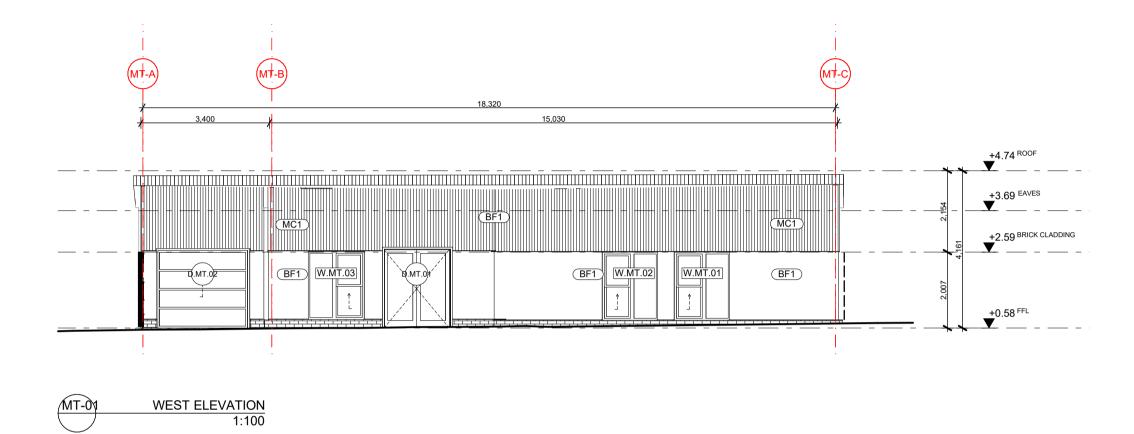

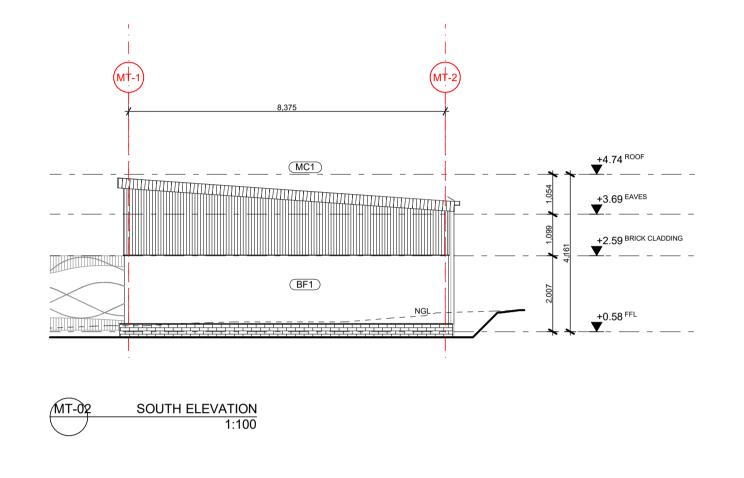

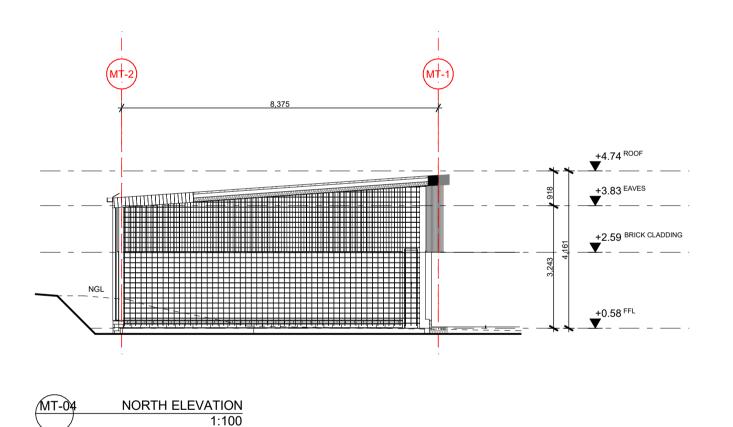

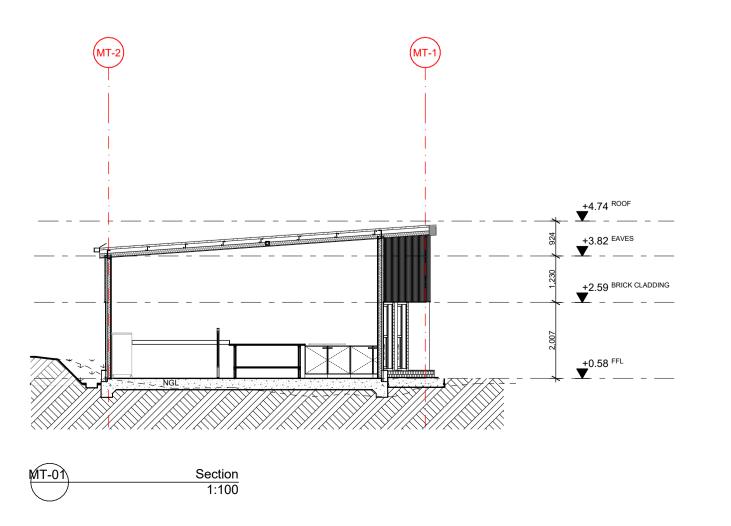

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Weathergroove - Natural 75mm

- Basalt

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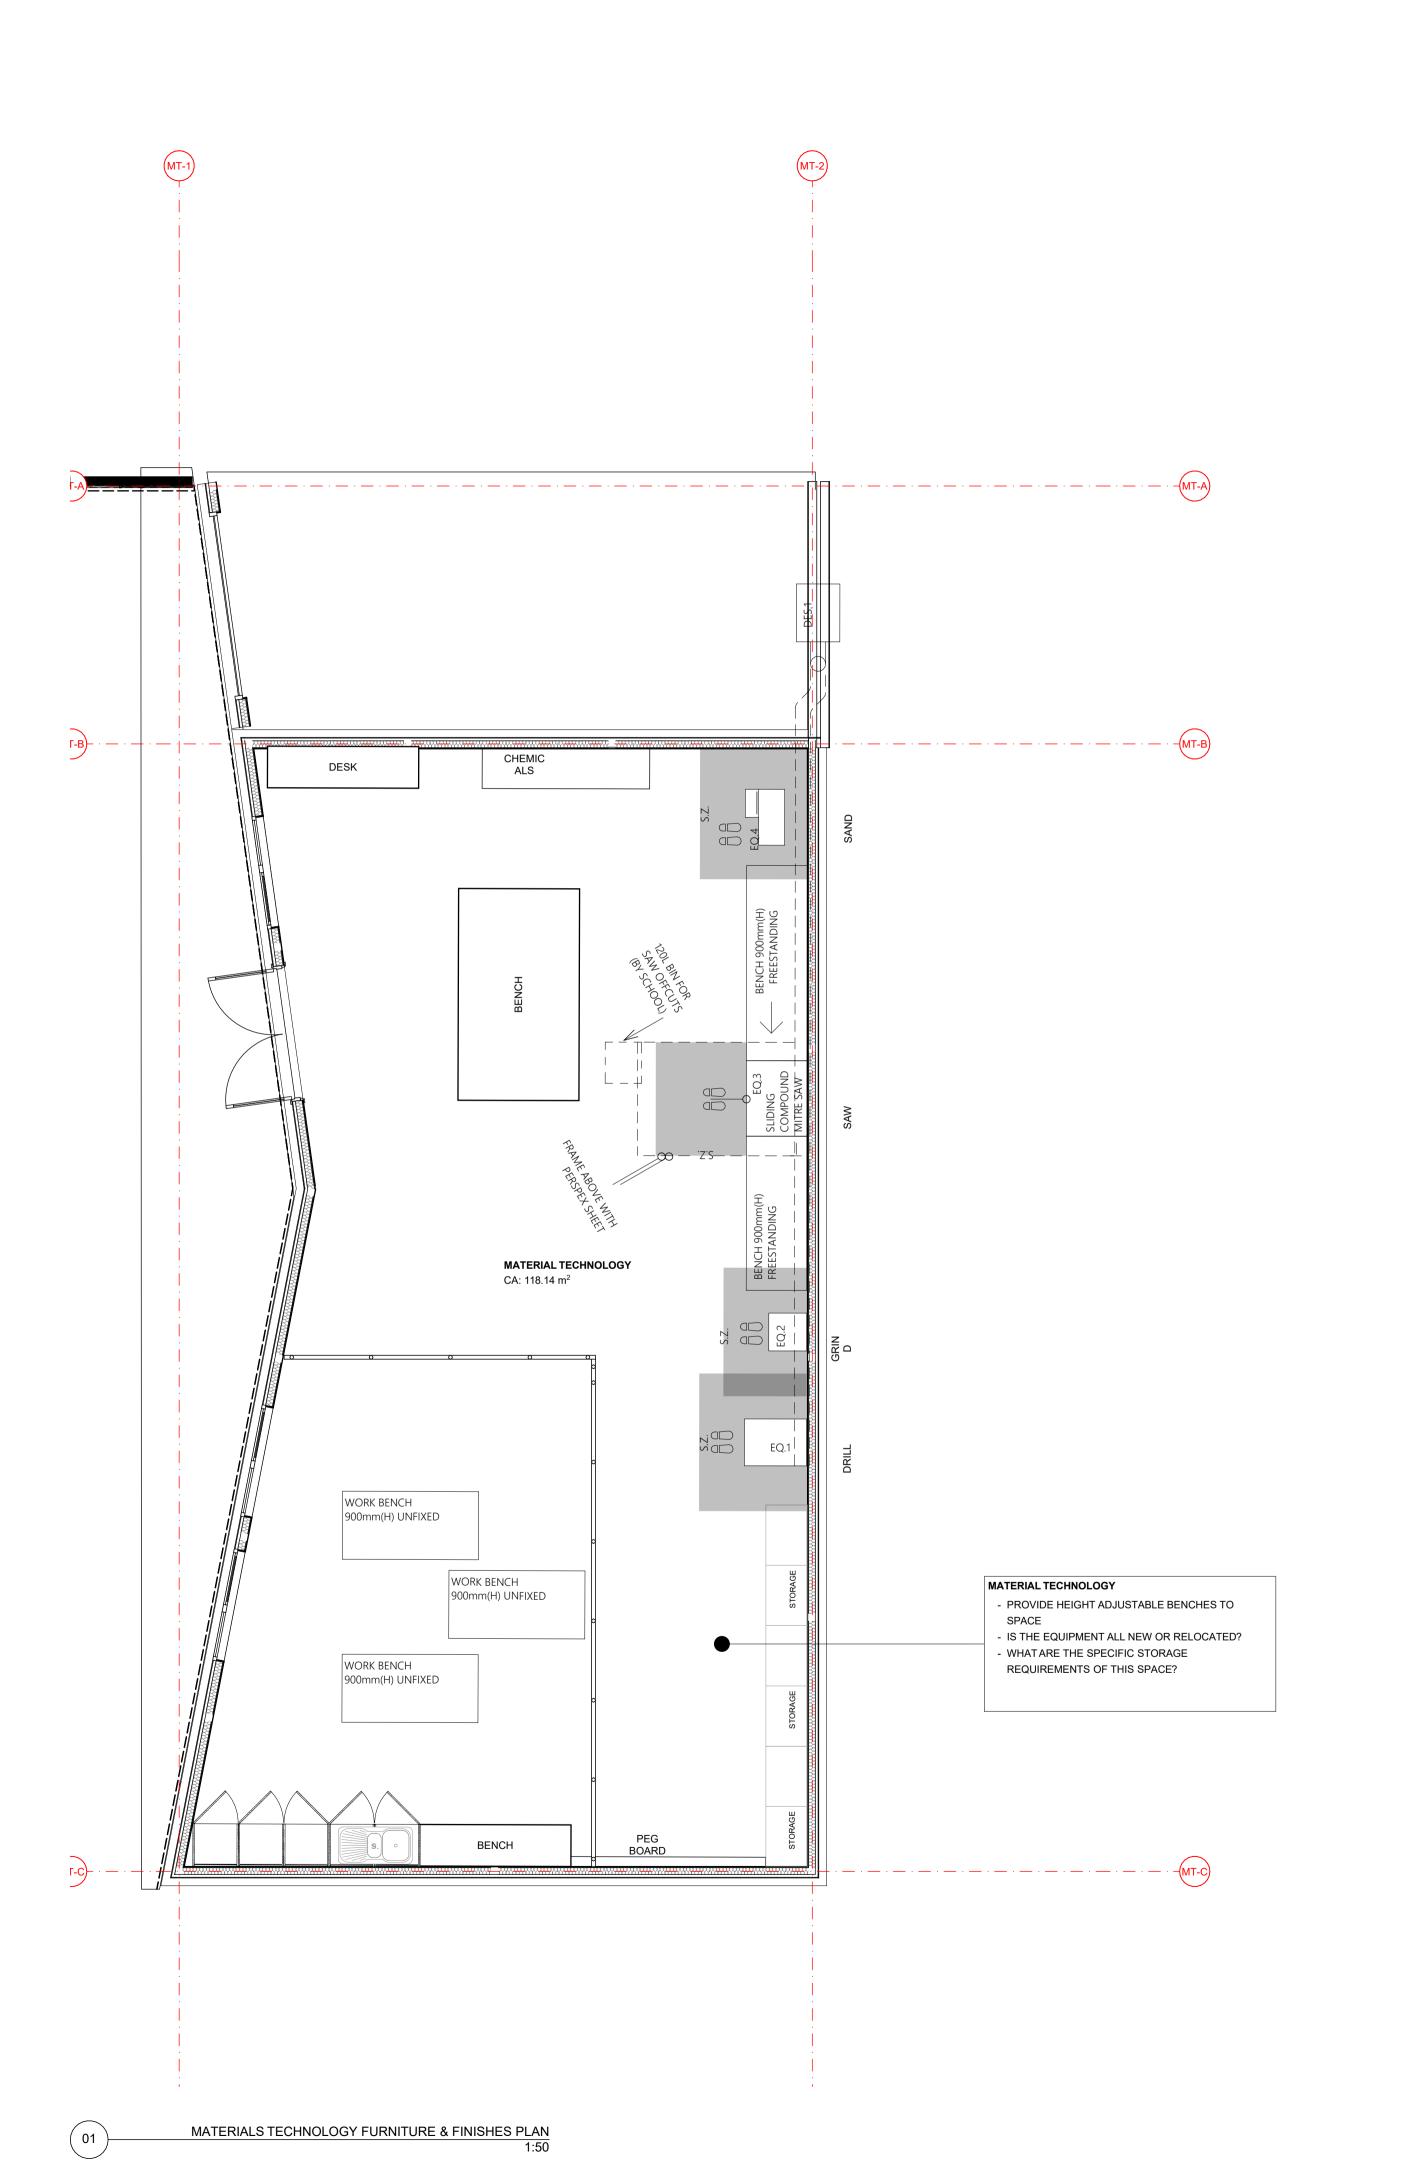
Victorian School Building Authority


CAD FILE 2105 BVS Stage 2 - DD

Barwon Valley School - Stage 2

MT Elevations and Sections

SCALE	1:100, 1:2000@ A1		
DRAWN	JP		
CHECKED	JM		
PLOT DATE	27/07/2021		
PROJECT	DWG NO.	-	REV
2105	DD.02.02		03



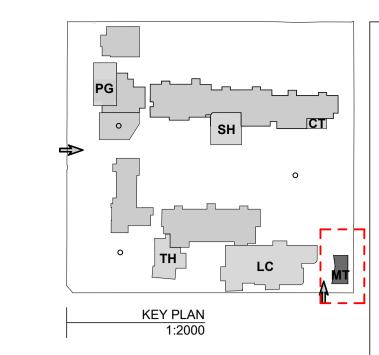

MATERIALS TECH INCLUSIONS
- PEDESTAL DRILL
- DOCKING SAW
- DUST EXTRACTOR
- PAINTING BOOTH
- WIFI & DATA
- LOCKABLE STORAGE
- MECHANICAL VENTILATION

REV	DATE	BY	CH	DESCRIPTION
01	14/07/2021	AJ	JM	DD DESIGN MEETING
02	16/07/2021	AJ	JM	FOR QS REVIEW
03	27/07/2021	AJ	JM	FOR BUILDING SURVEYOR

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ABN 44 005 000 859 ARBV 50053

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Victorian School Building Authority

76-94 Laura *F* 3216

0210

CAD FILE 2105 BVS Stage 2 - DD


PROJECT

Barwon Valley School - Stage 2

MT Furniture & Finishes Plan

2105	1	DD.02.03	03
PROJECT	- 1	DWG NO.	REV
PLOT DATE		27/07/2021	
CHECKED		JM	T /
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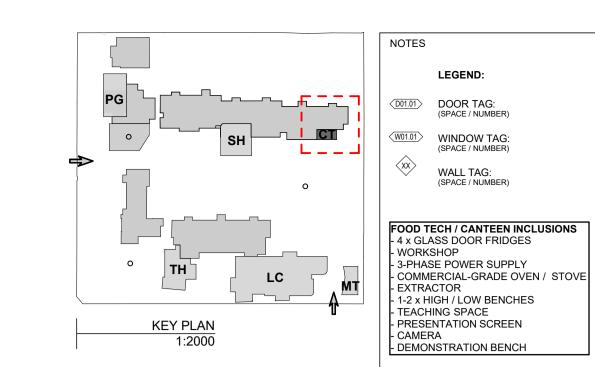


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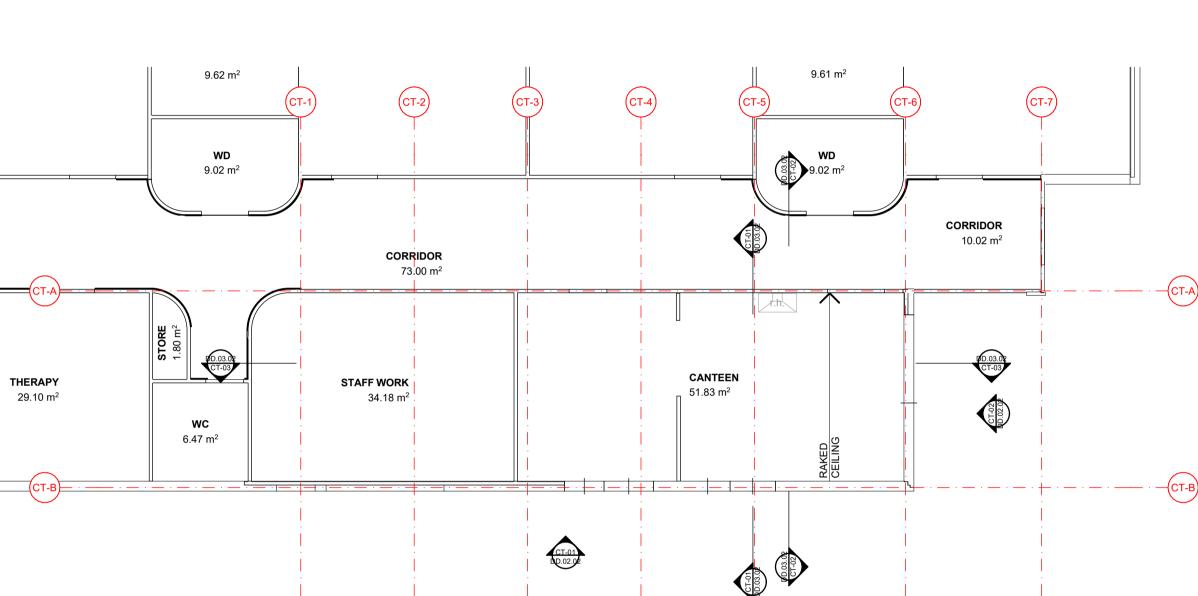
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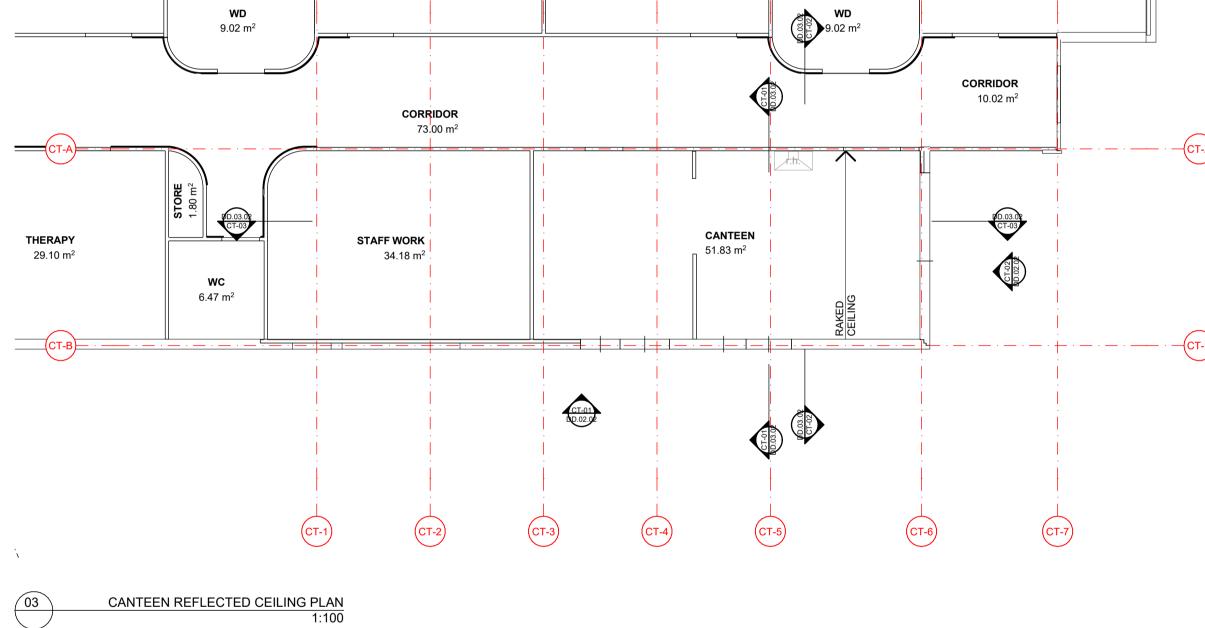
54_y 2,716 ,719 ,

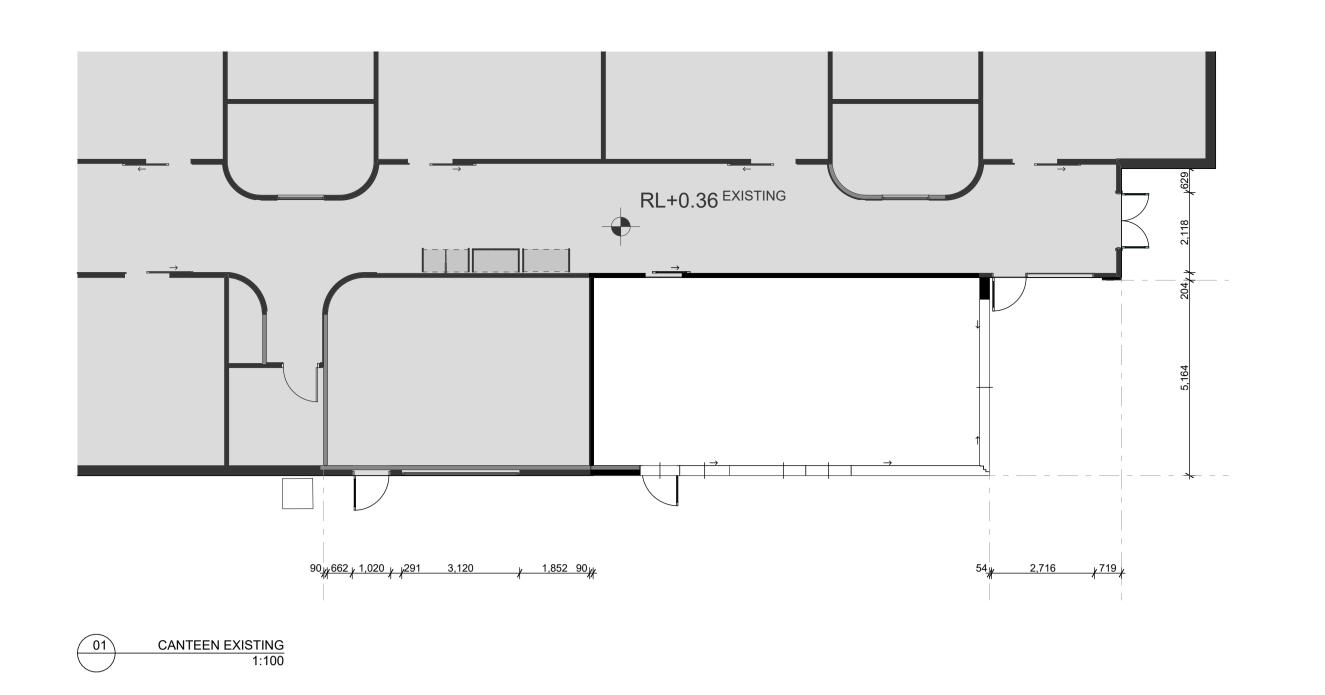
CT-6




LEGEND:





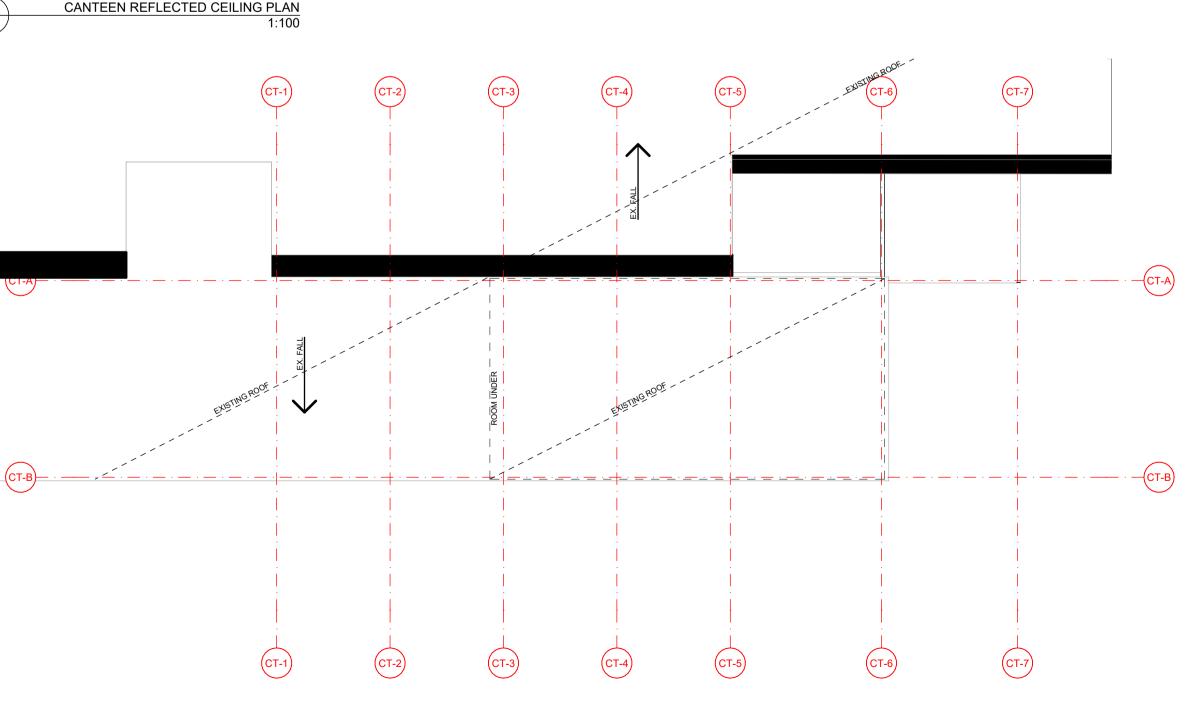

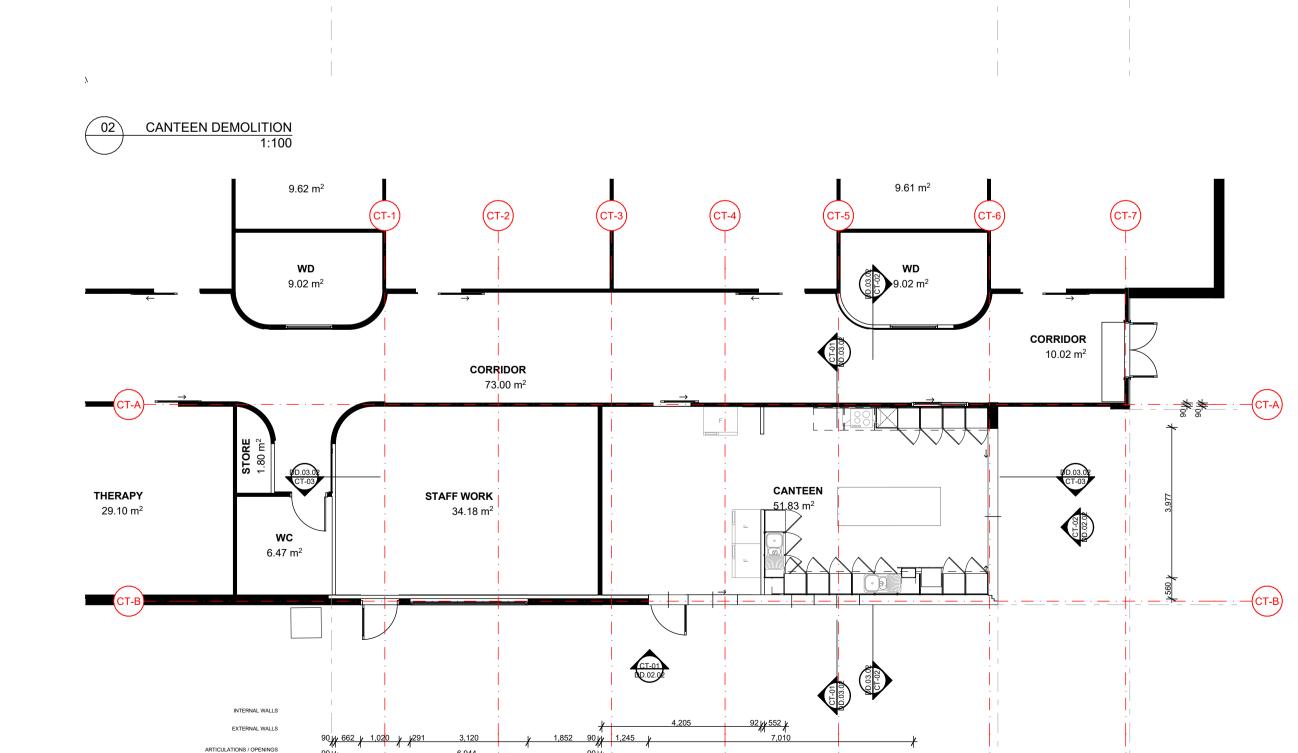

90 yr 662 y 1,020 y 291 3,120 y 1,852 90 yr

EXTENT OF BUILDING

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 FOR QS REVIEW

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COORDINATION
04 27/07/2021 JP JM FOR BUILDING SURVEYOR

PROJECT ADDRESS 76-94 Laura Ave, Belmont VIC

Victorian School Building Authority CAD FILE 2105 BVS Stage 2 - DD

PROJECT Barwon Valley School - Stage 2

TITLE CT Plans 1

SCALE	1:10	00, 1:2000@ A1		
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PLOT DATE		27/07/2021		1
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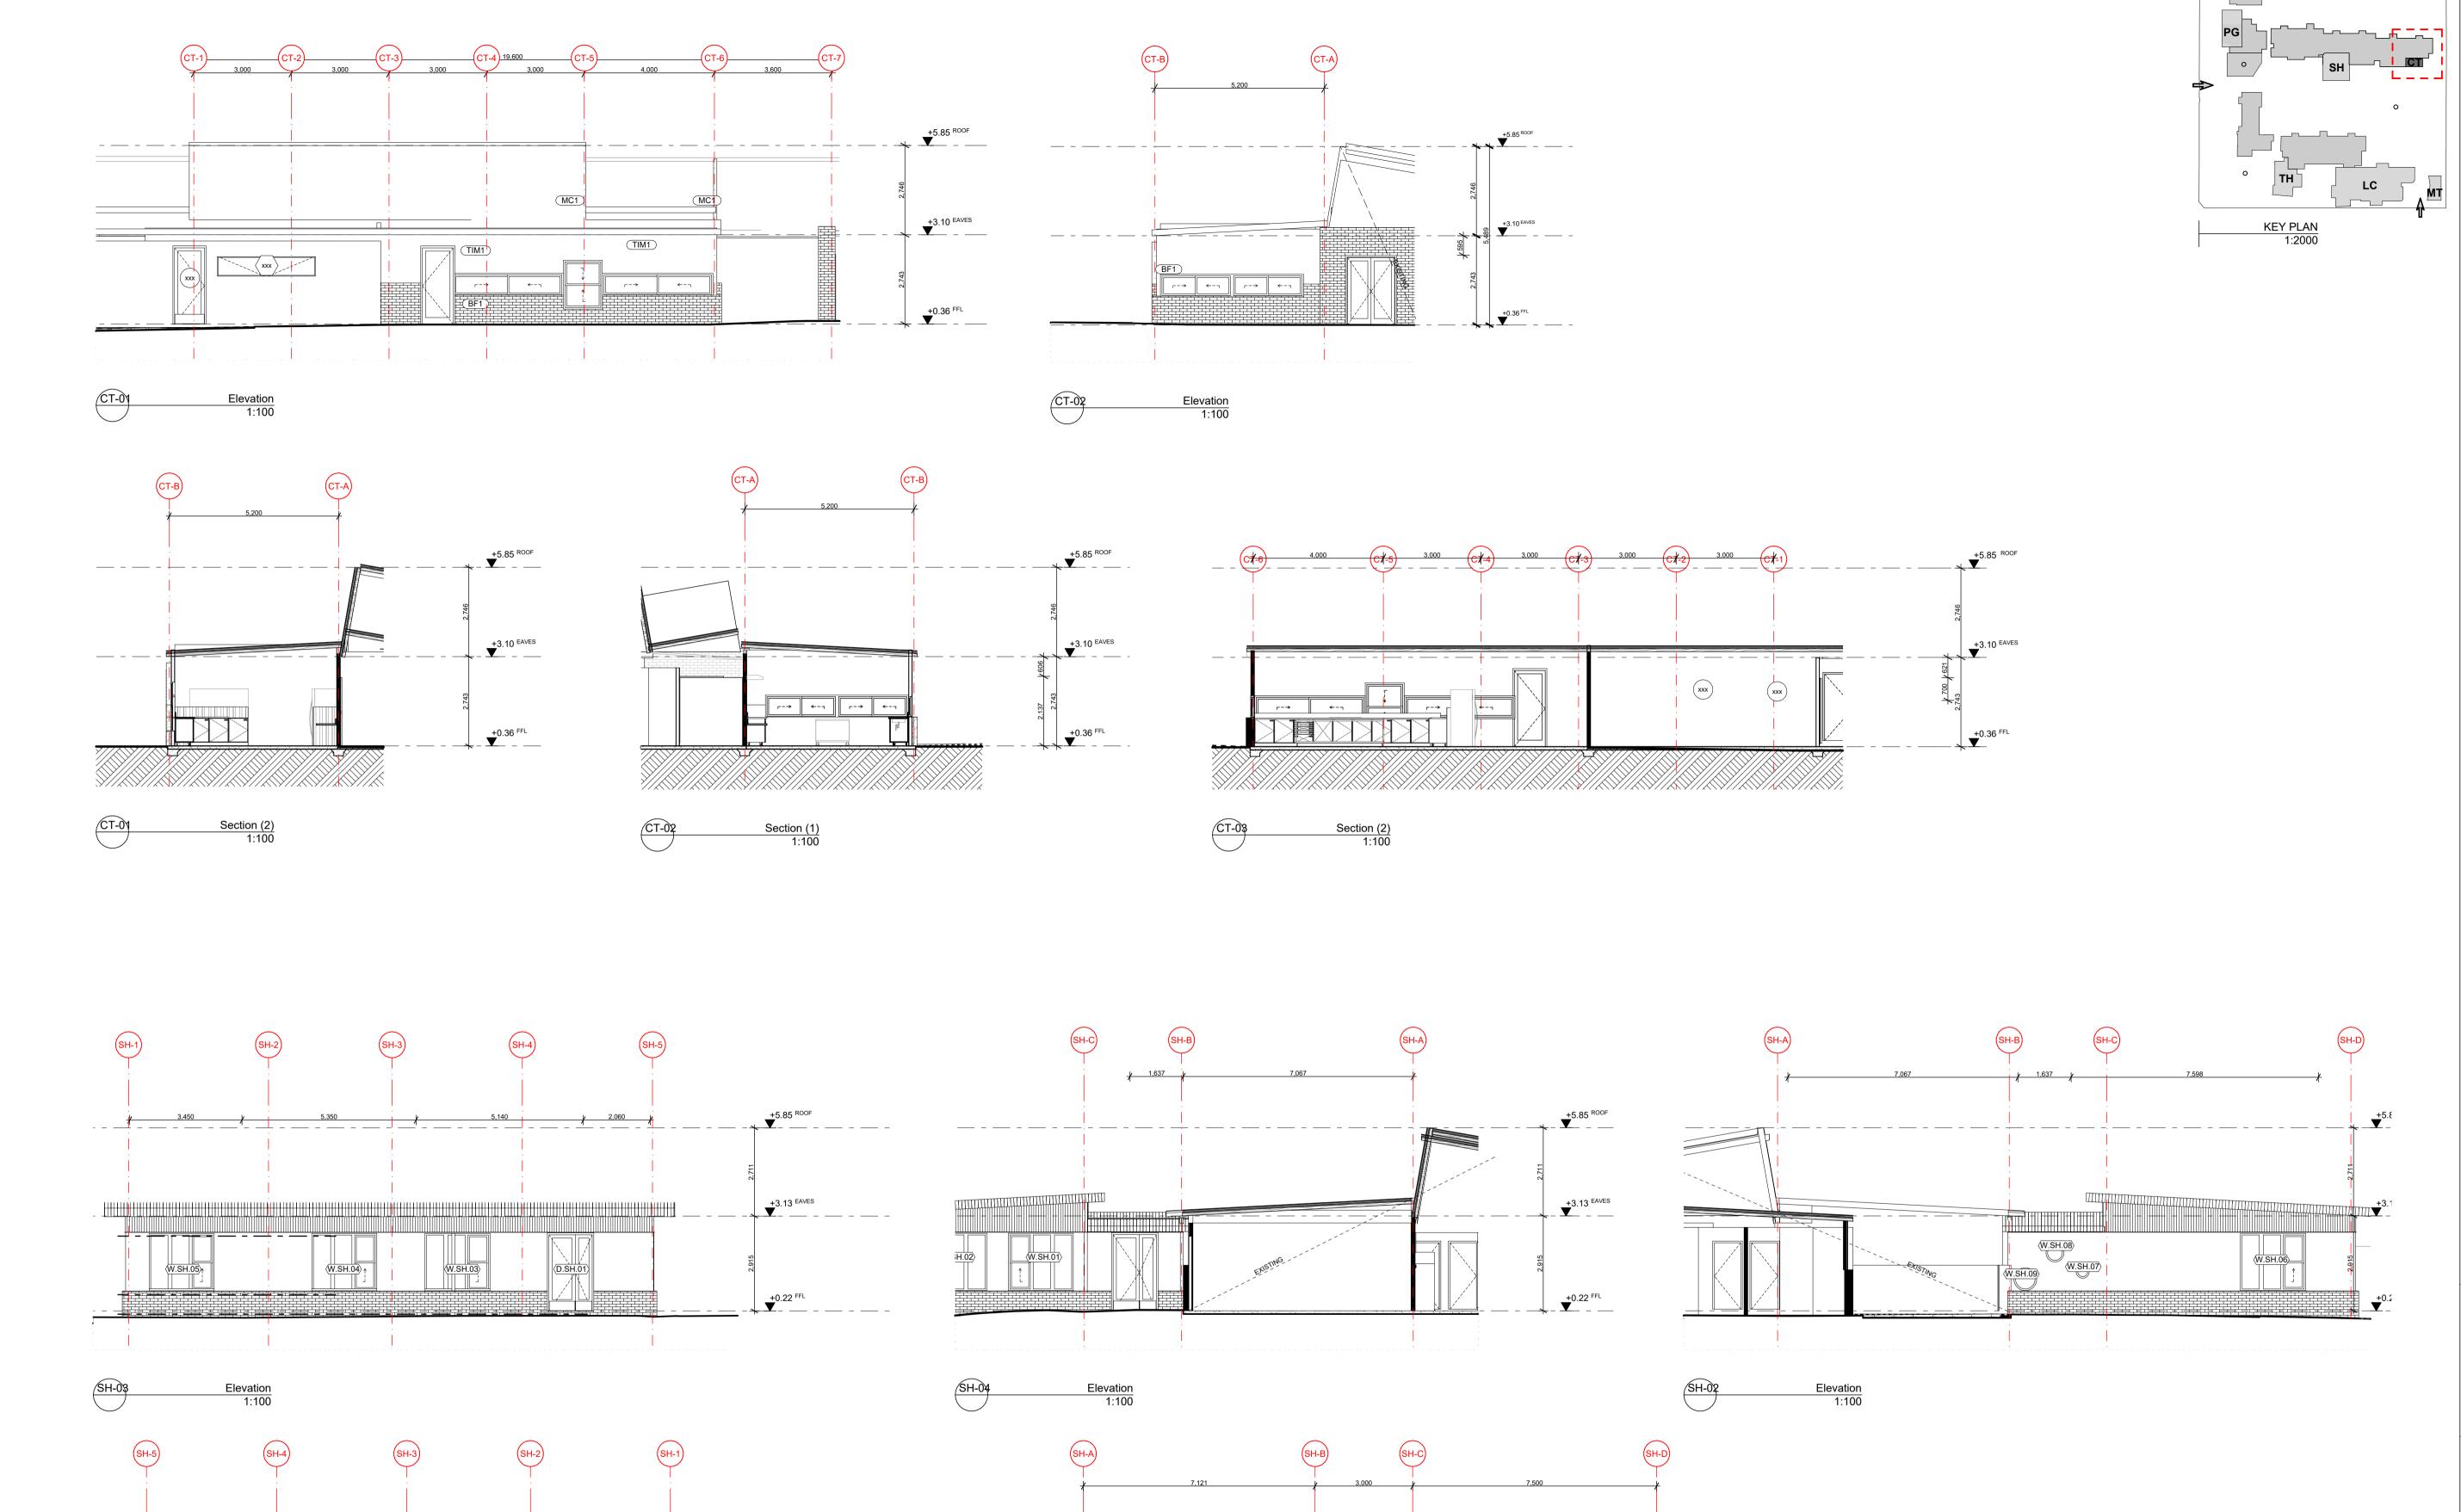
2105 | DD.03.01 | 04

CANTEEN PROPOSED

CT-4

(CT-5)

CANTEEN ROOF PLAN 1:100



SCIENCE

Section (2) 1:100

1 3,800 4,300 +5.85 ROOF

STORE

↑ (W.SH.05)

+3.13 EAVES

+0.22 FFL

HALL (EX.)



CT Elevations and Sections 1

SCALE DRAWN CHECKED

PLOT DATE
PROJECT

2105

1:100, 1:2000@ A1


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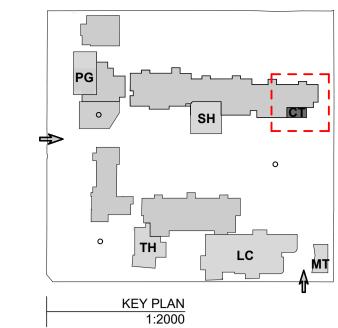
DD.03.02 | 03

27/07/2021

DWG NO.

NOTES



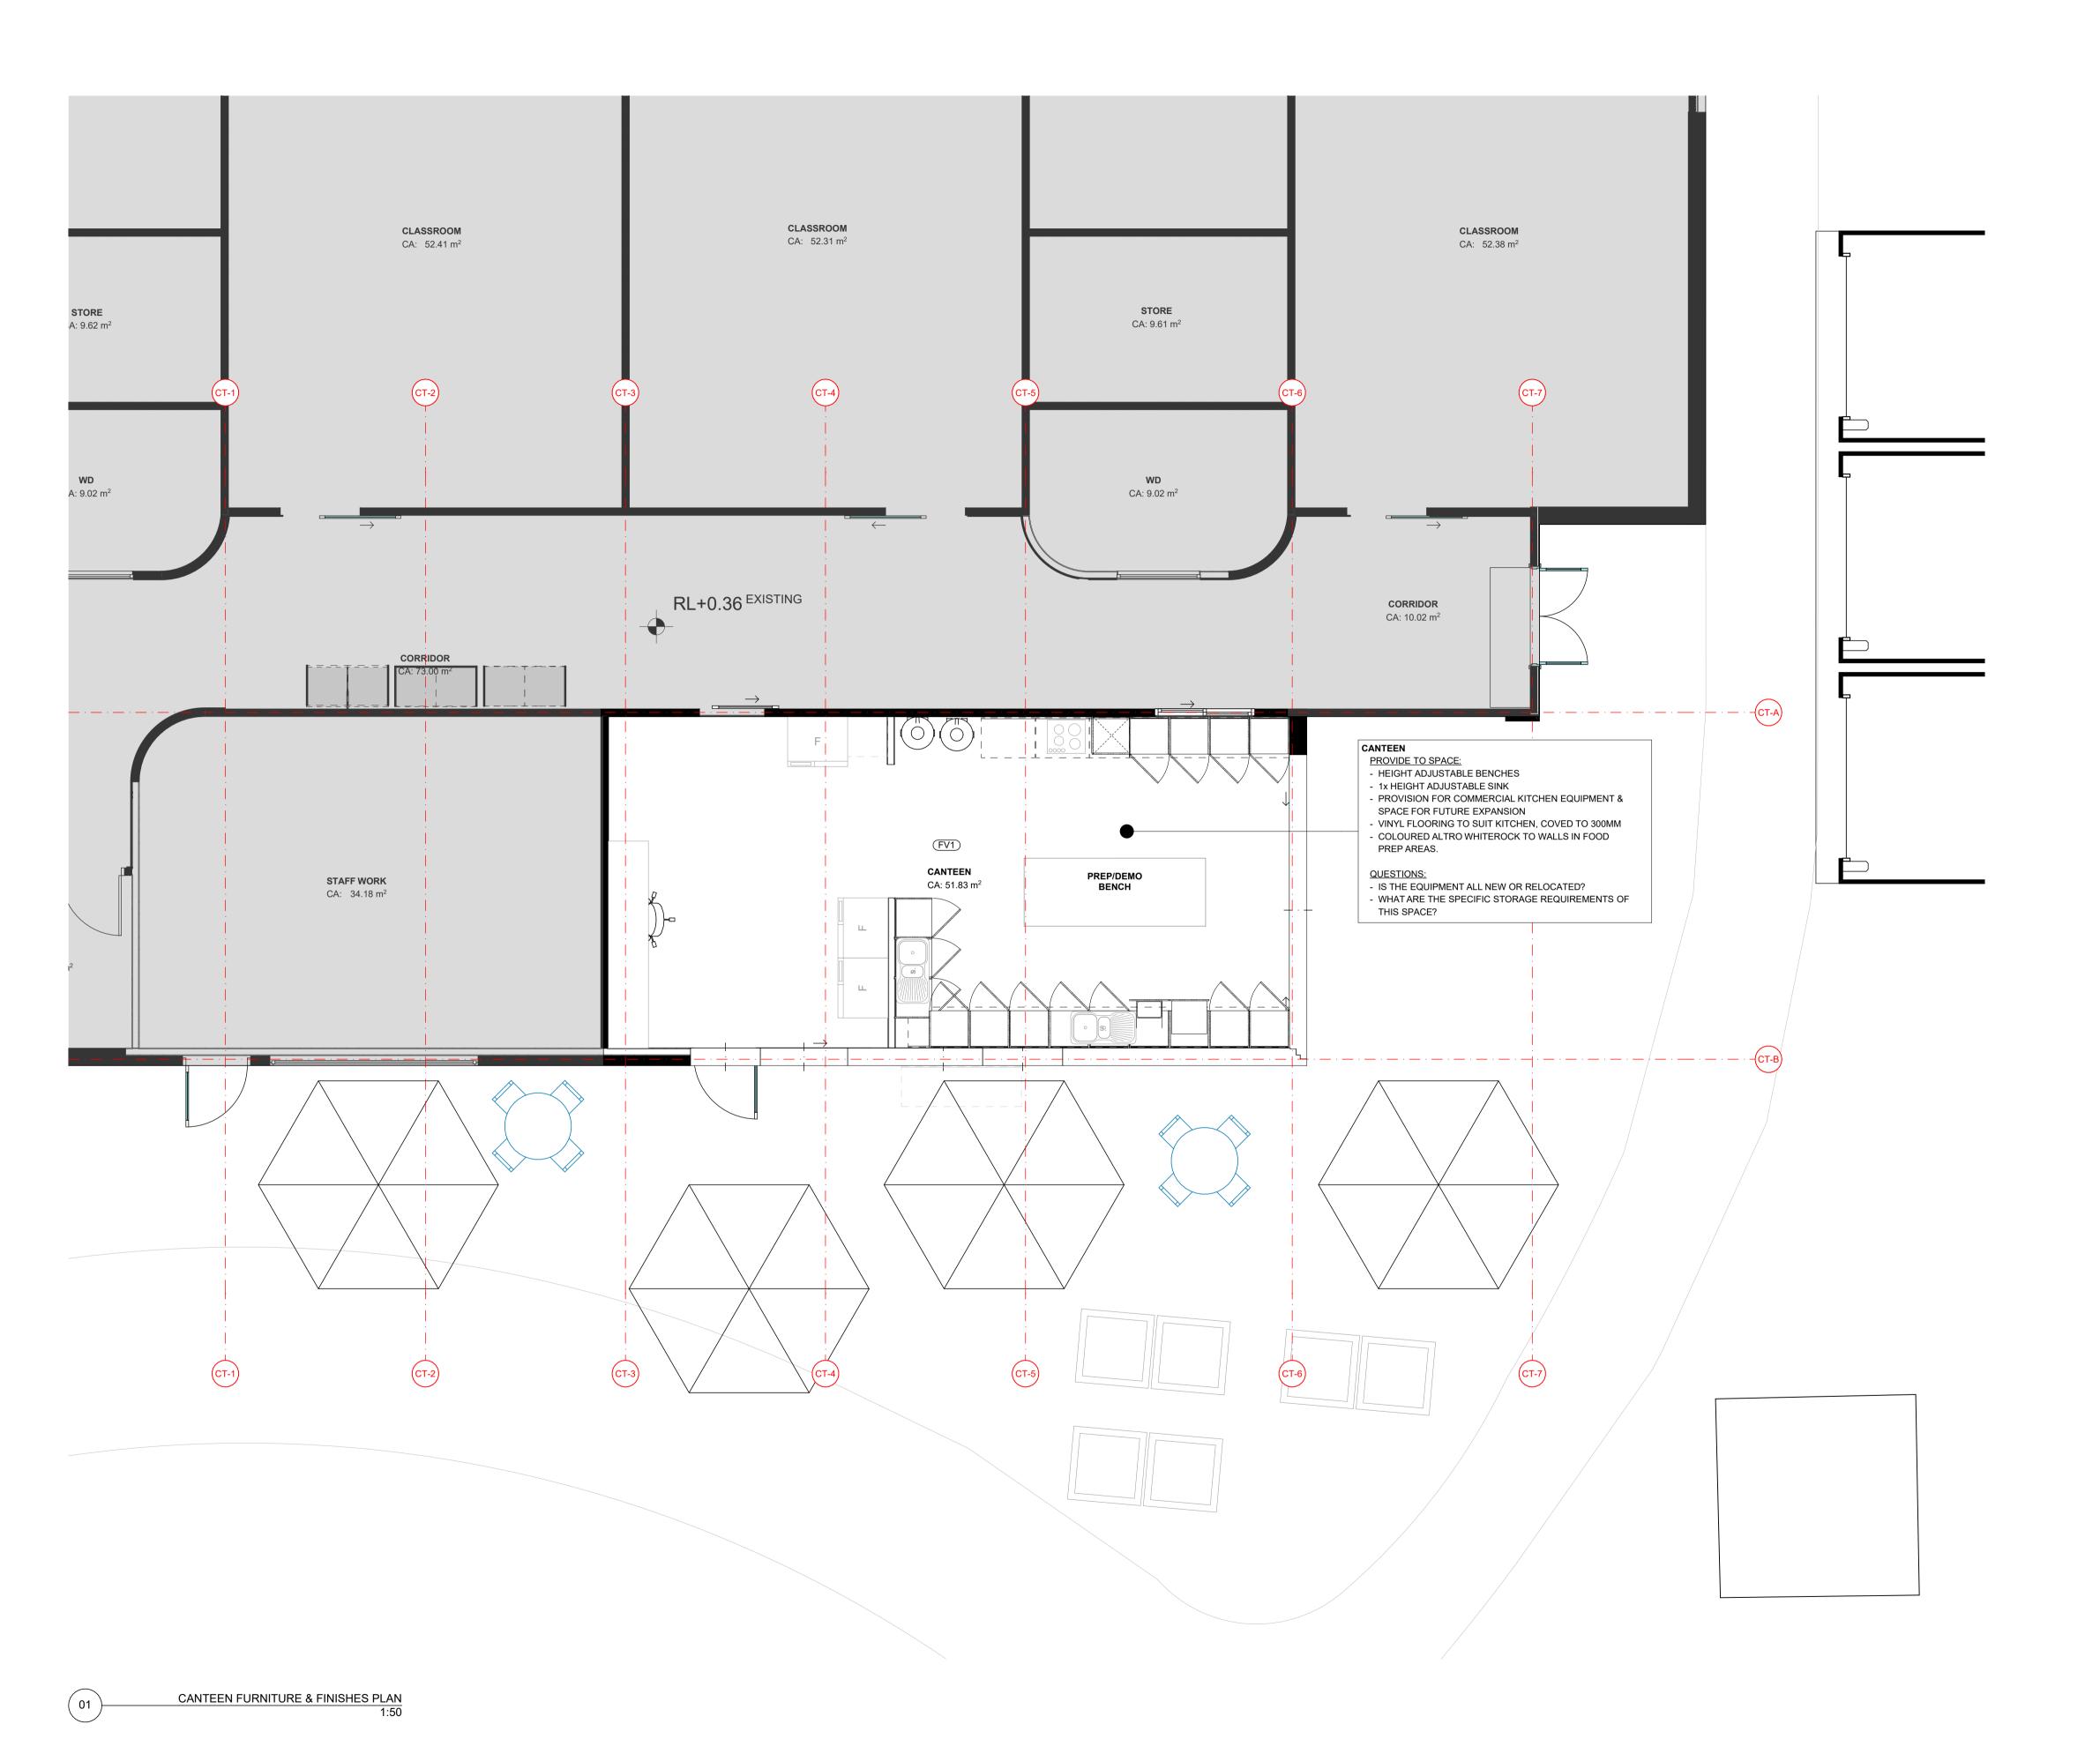

FOOD TECH / CANTEEN INCLUSIONS
- 4 x GLASS DOOR FRIDGES
- WORKSHOP
- 3-PHASE POWER SUPPLY
- COMMERCIAL-GRADE OVEN / STOVE
- EXTRACTOR
- 1-2 x HIGH / LOW BENCHES
- TEACHING SPACE
- PRESENTATION SCREEN
- CAMERA
- DEMONSTRATION BENCH

	DATE	DV	CII	DESCRIPTION
REV		BY	CH	
01	14/07/2021	AJ	JM	DD DESIGN MEETING
)2	16/07/2021	AJ	JM	FOR QS REVIEW
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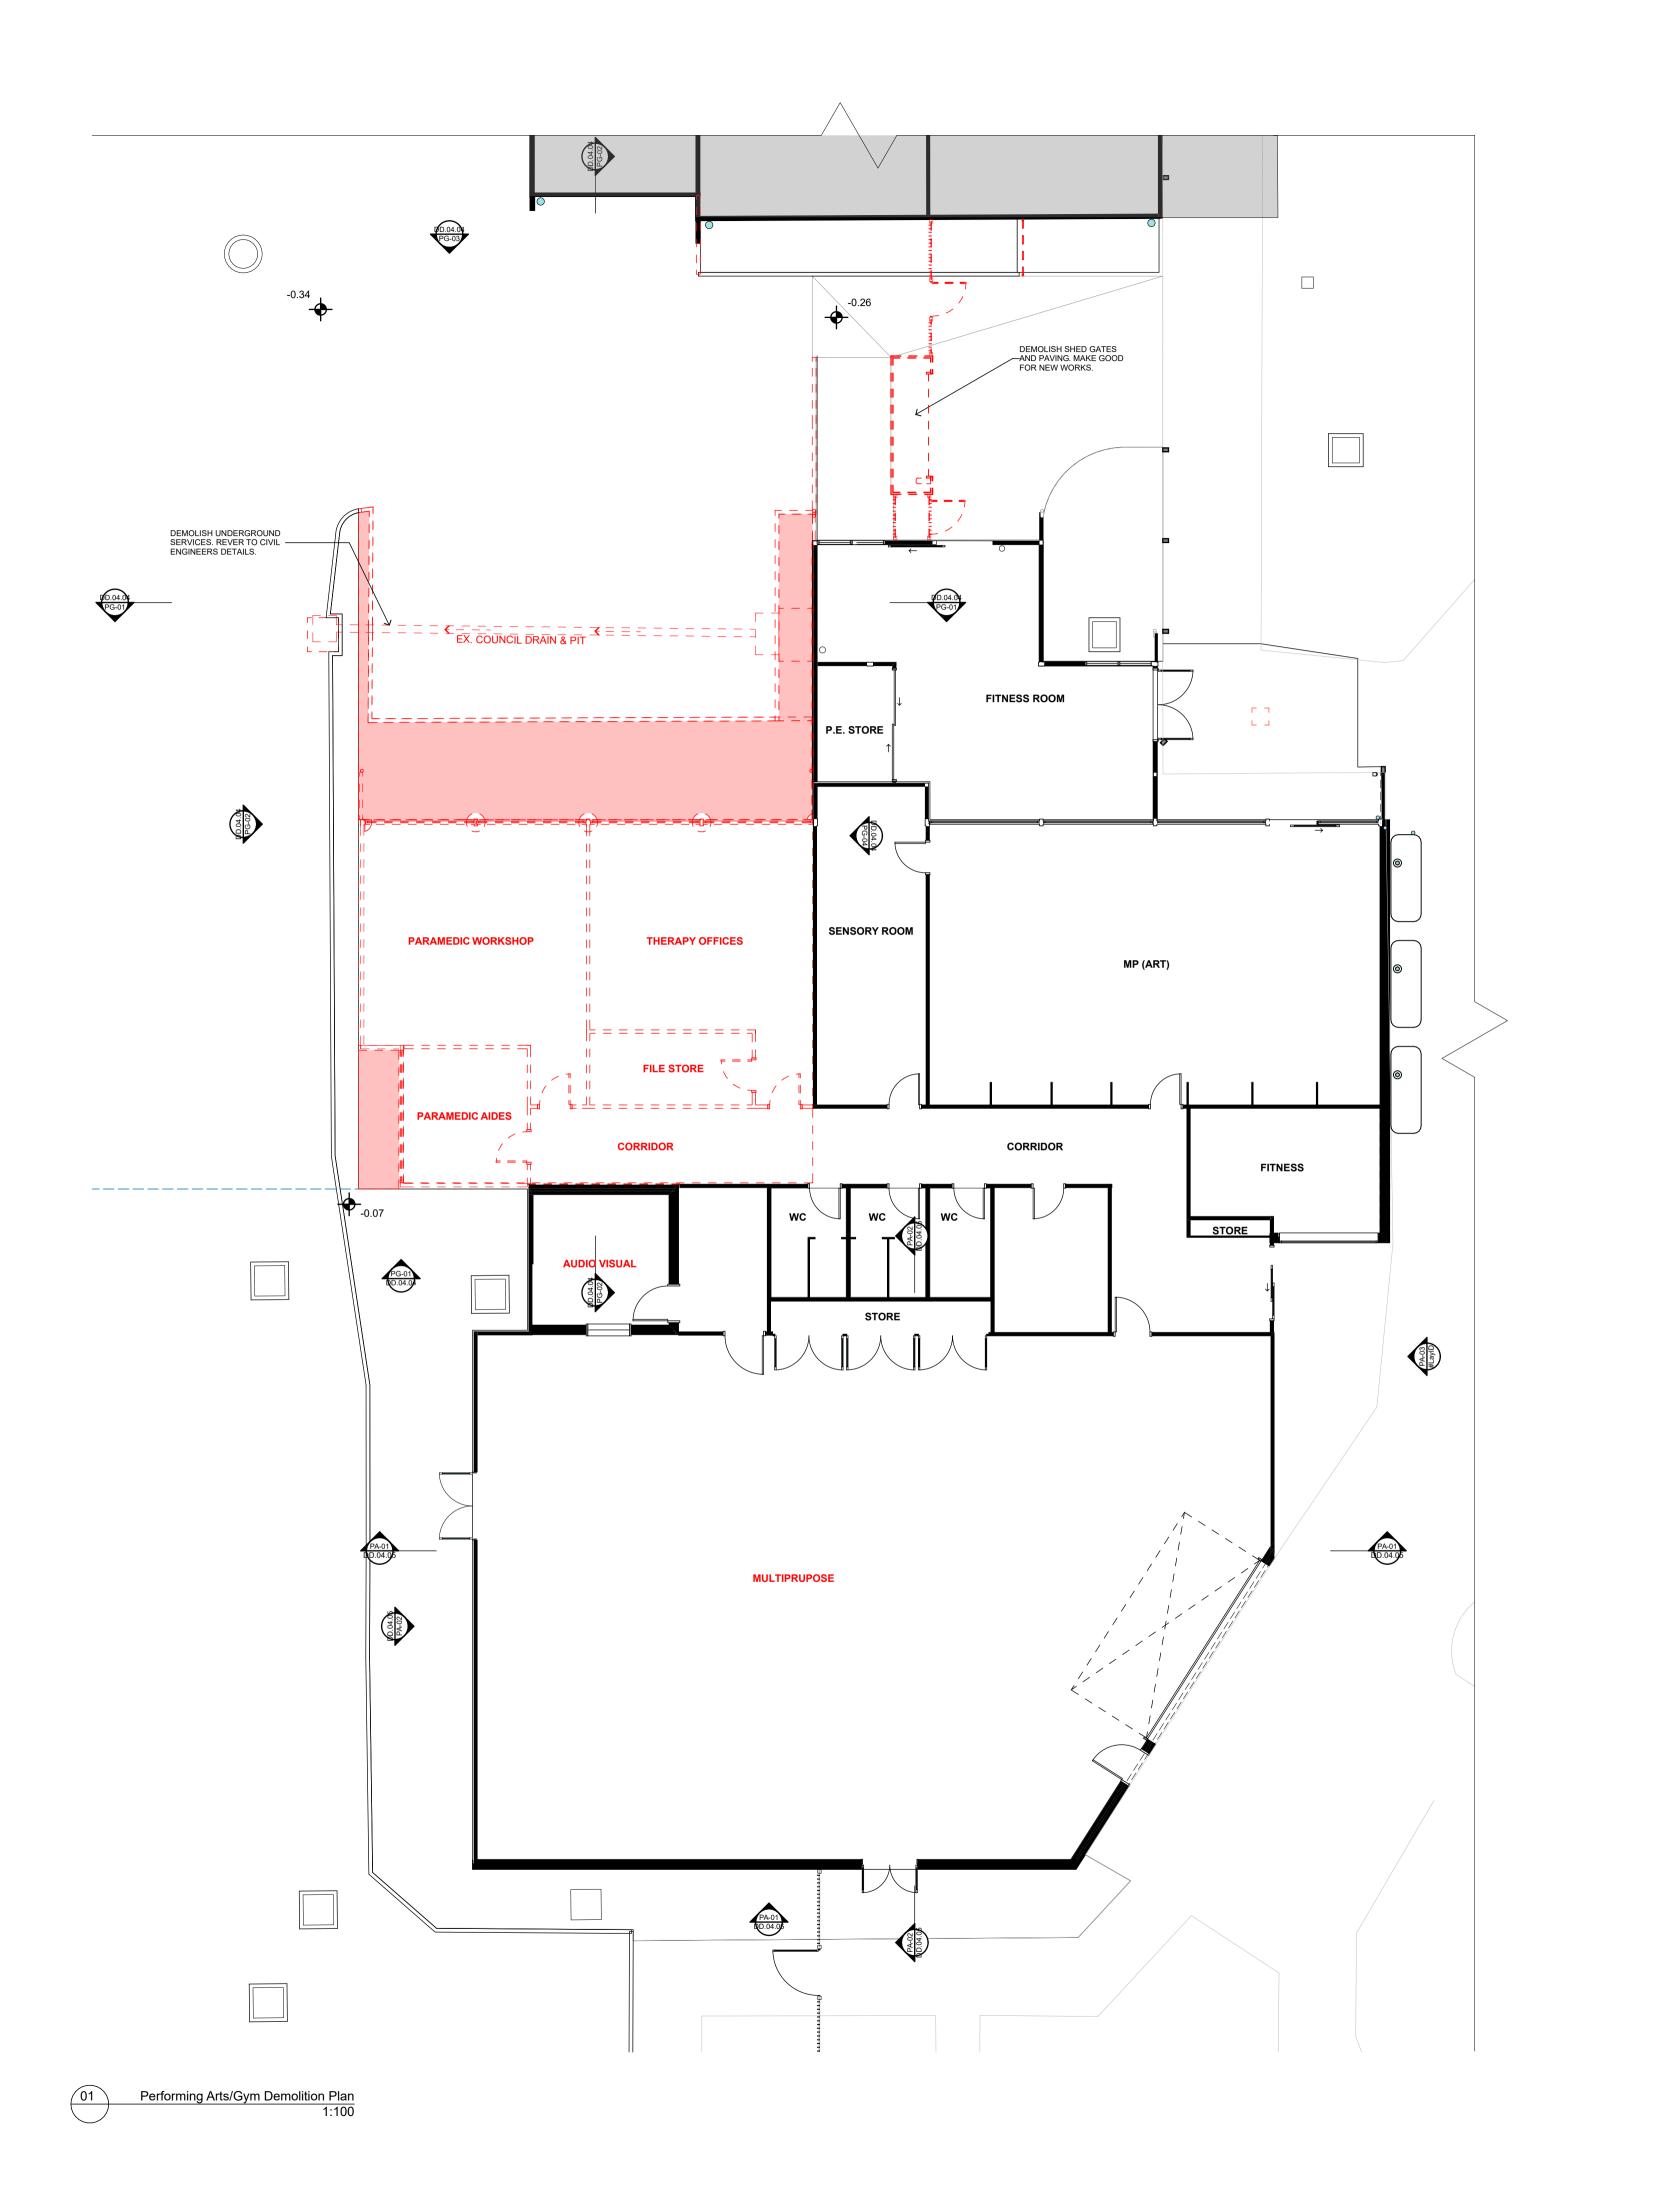
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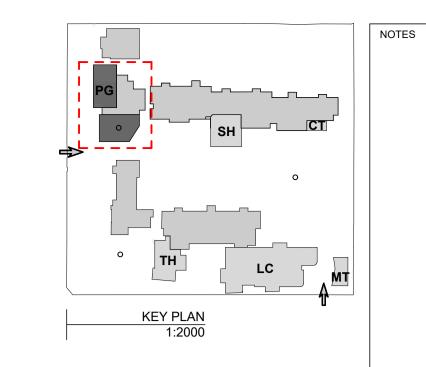
Barwon Valley School - Stage 2

TITLE

CT Furniture & Finishes Plan

2105	DD.03.04	I	03
PROJECT	DWG NO.	ı	REV
PLOT DATE	27/07/2021		
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DRAWN	JP		
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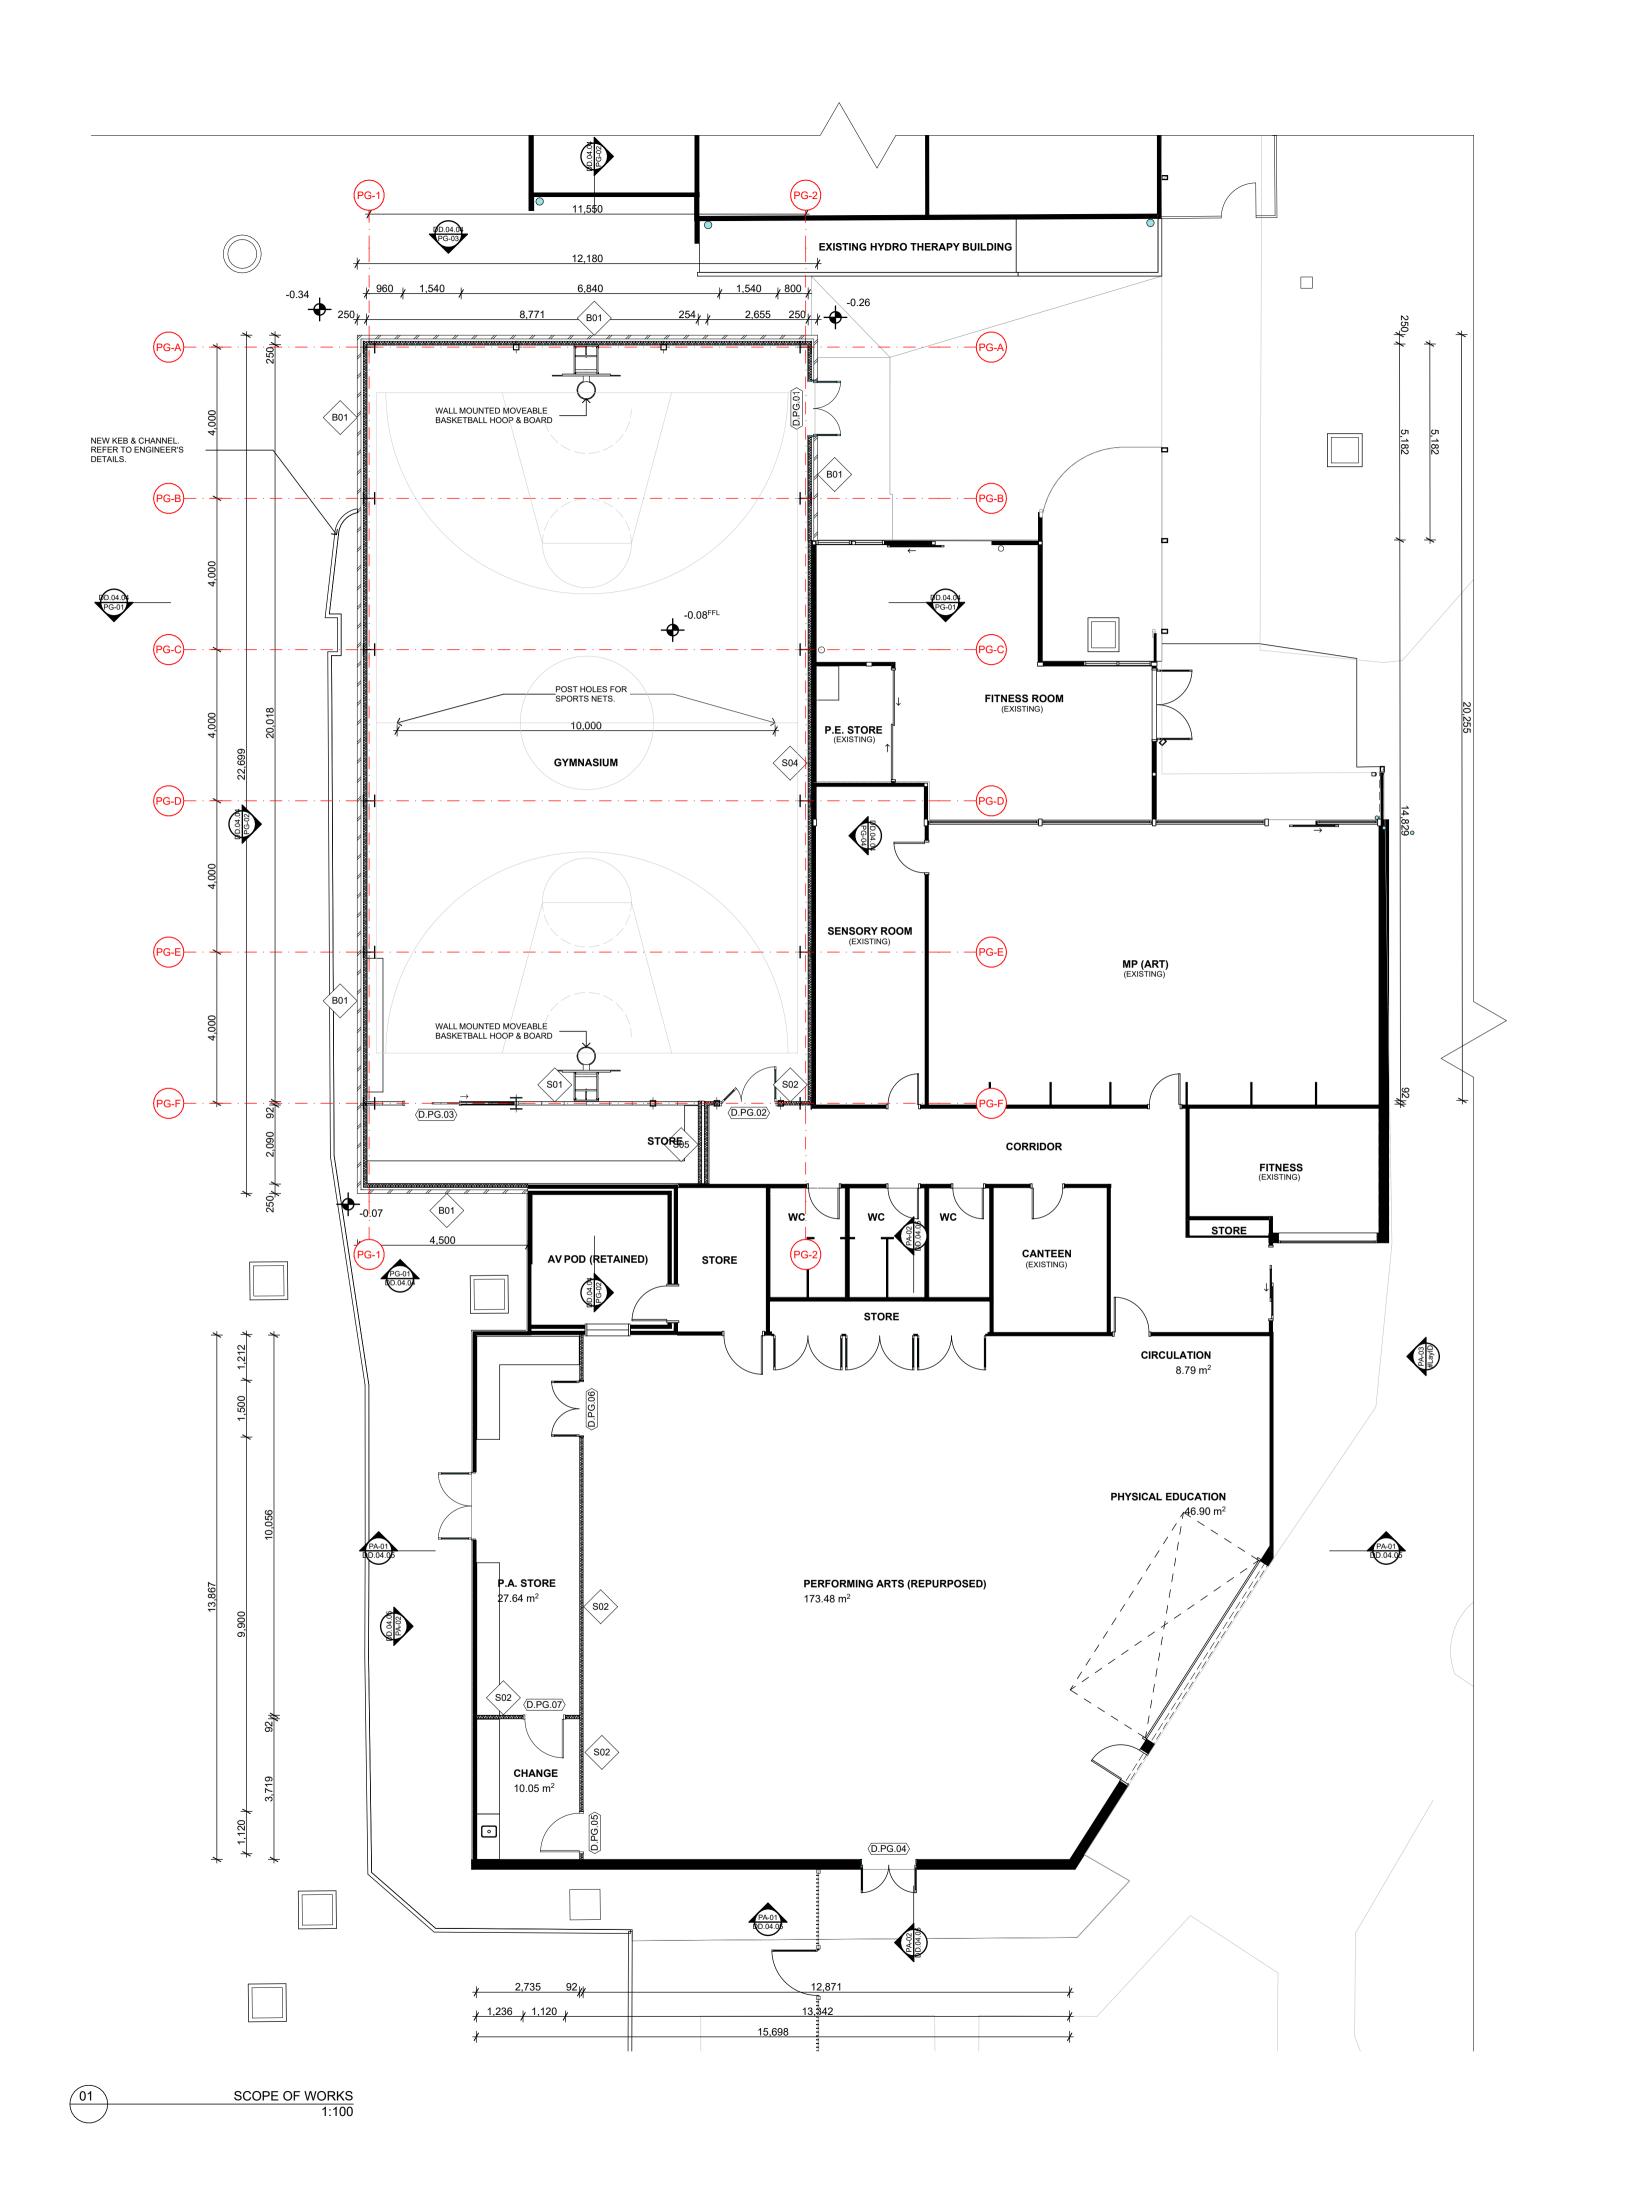
Victorian School Building Authority


CAD FILE 2105 BVS Stage 2 - DD PROJECT

Barwon Valley School - Stage 2

PG Demolition Floor Plan

2105	DD.04.01	0:
PROJECT	DWG NO.	RE
PLOT DATE	27/07/2021	
CHECKED	JM	
DRAWN	JP	
SCALE	1:100, 1:2000@ A1	



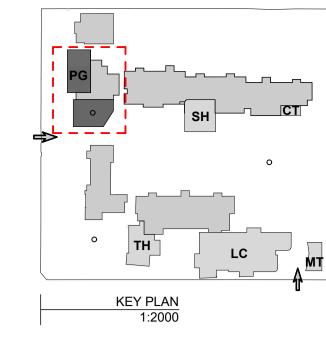

NOTES

LEGEND:

WINDOW TAG: (SPACE / NUMBER)

WALL TAG: (SPACE / NUMBER)

AREA	
Zone Category	Calculated Area
GA GYMNASIUM	233.15
ga storage	18.98
PA MUSIC/DRAMA/DANCE	173.48
PA STORAGE	37.69
	463.30 m ²

REV	DATE	BY	CH	DESCRIPTION
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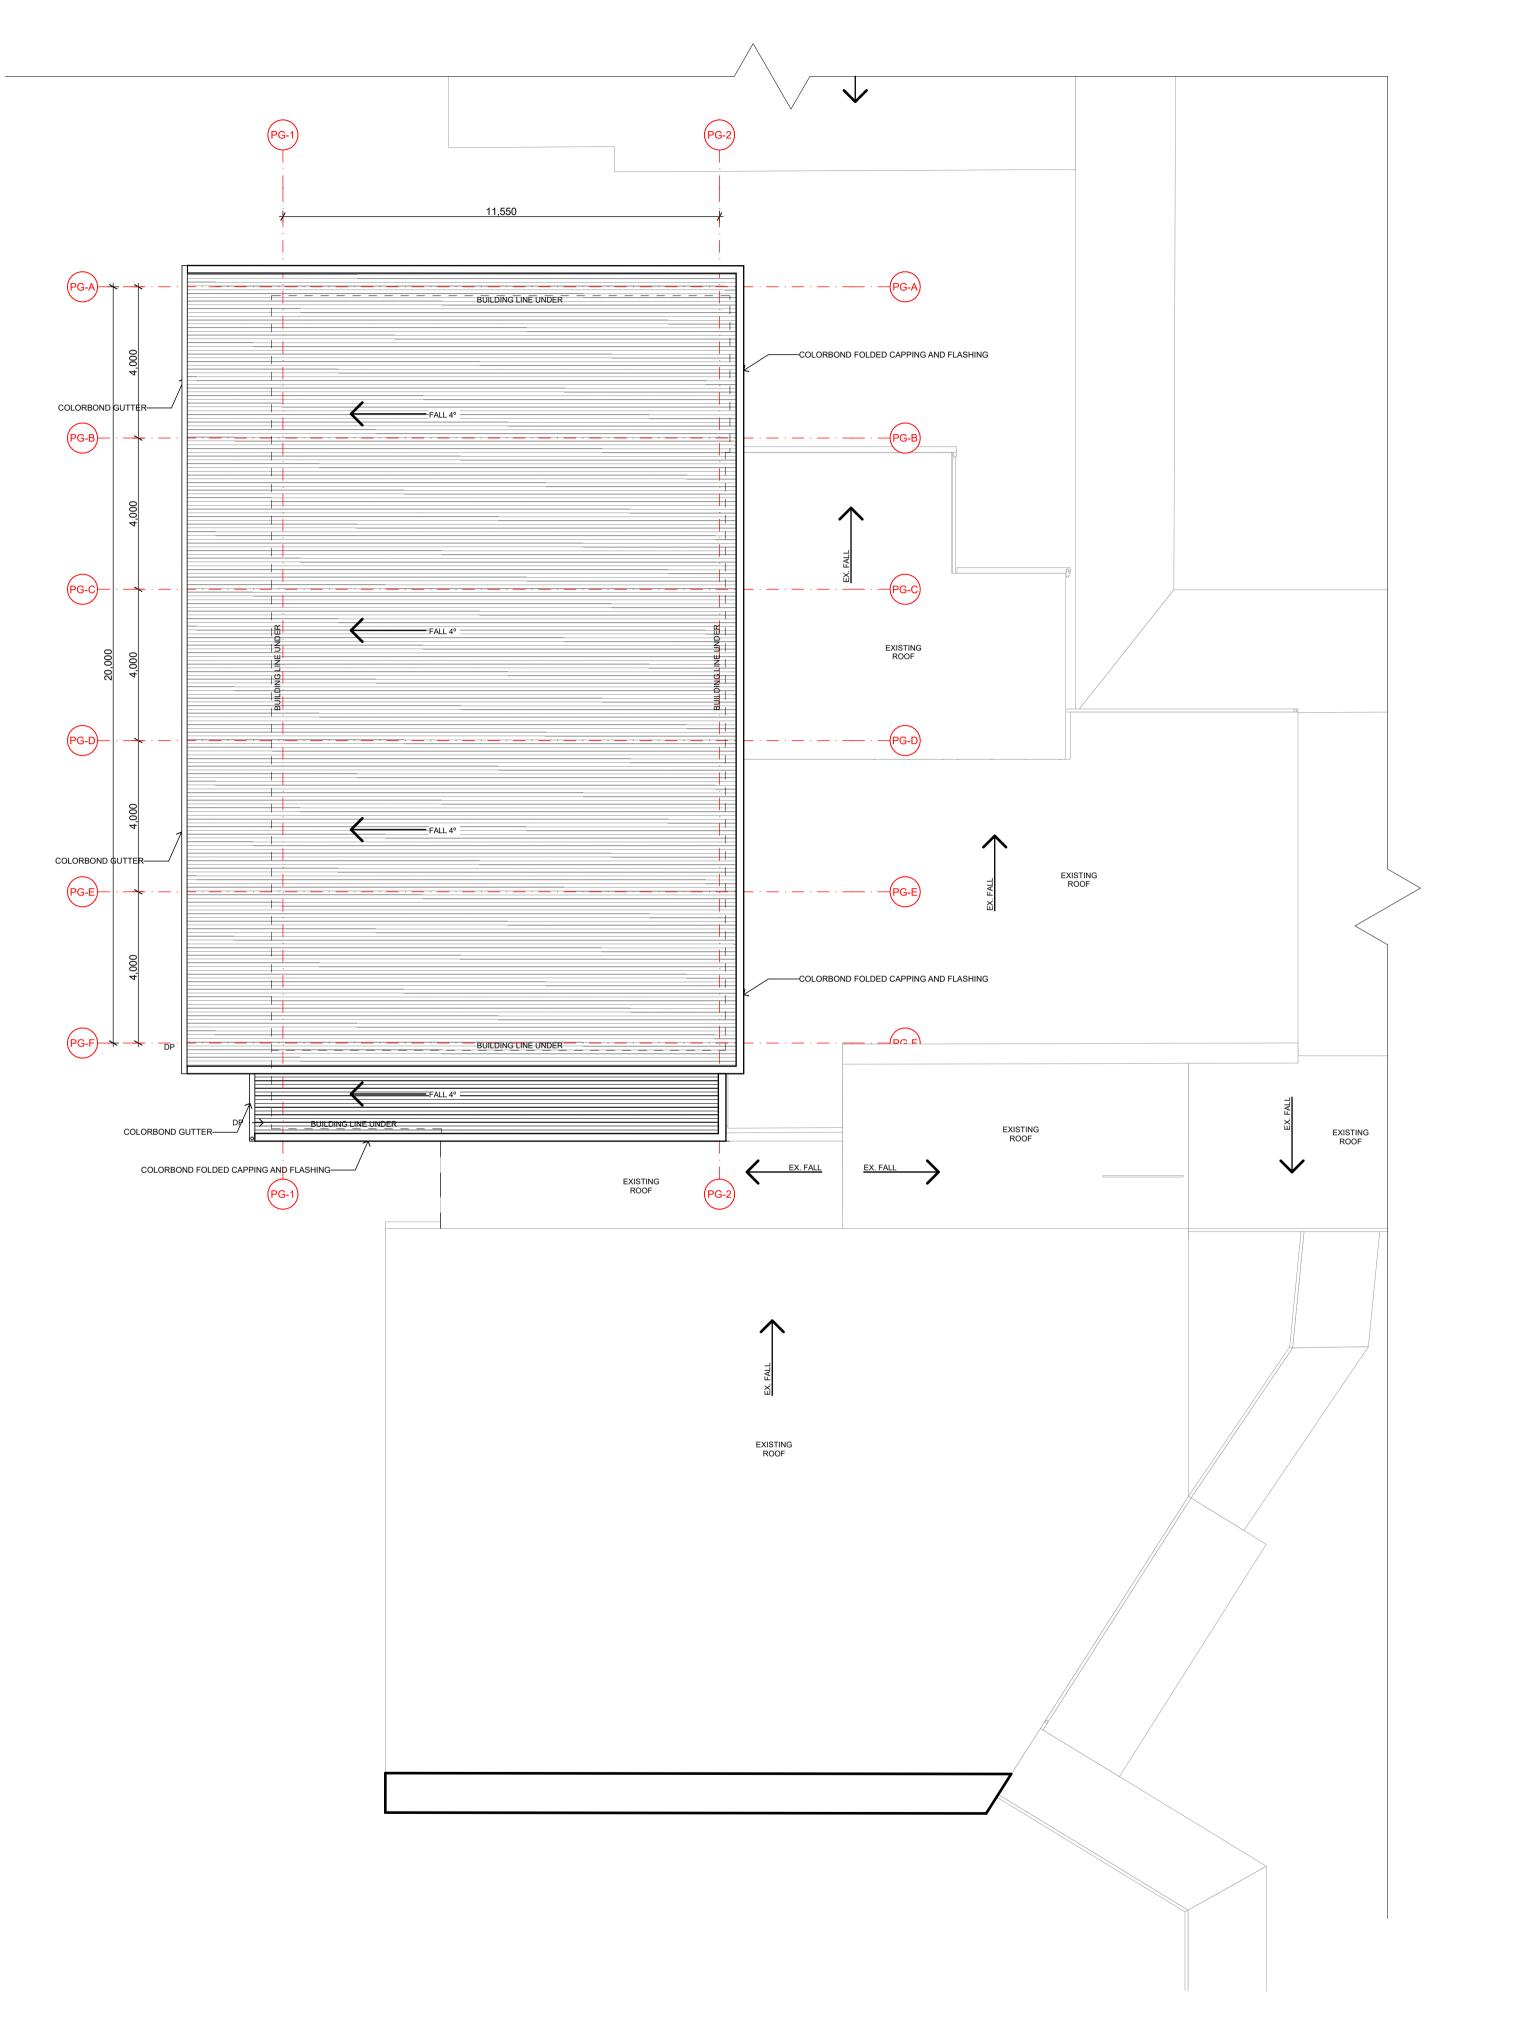
Victorian School Building Authority


CAD FILE 2105 BVS Stage 2 - DD

Barwon Valley School - Stage 2

PG Planned Floor Plan SCALE 1:100, 1:2000@ A1

DRAWN CHECKED PLOT DATE 27/07/2021 PROJECT DWG NO. 2105 DD.04.02 | 03



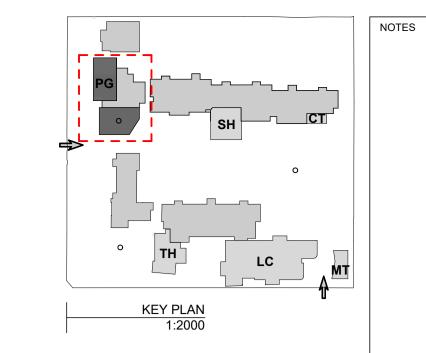

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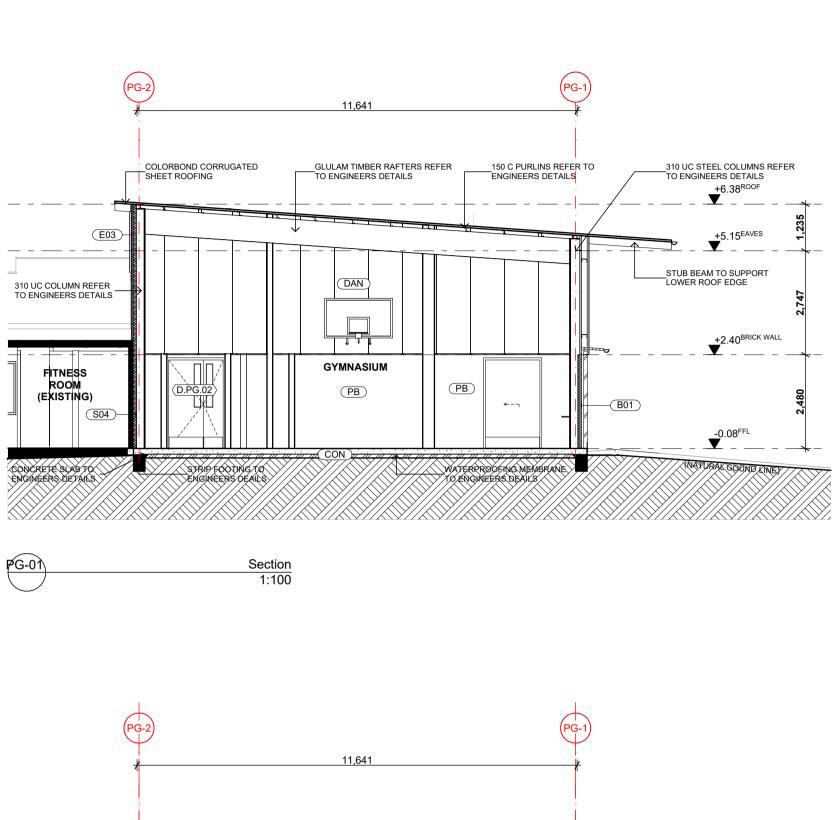
Victorian School Building Authority


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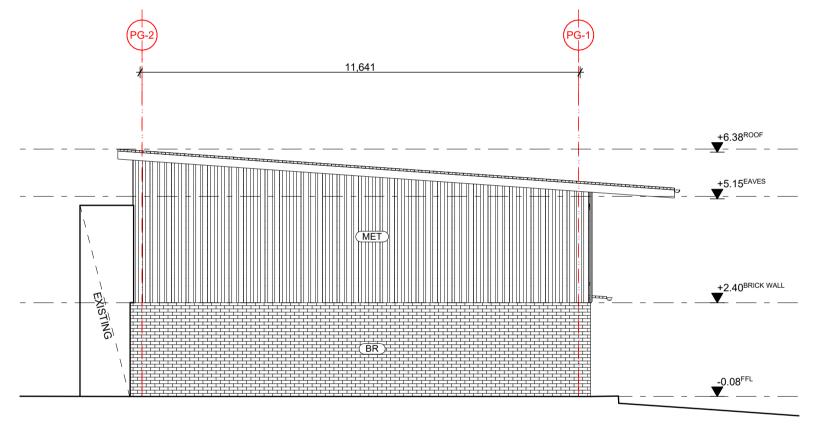
Barwon Valley School - Stage 2


PG Planned Roof Plan


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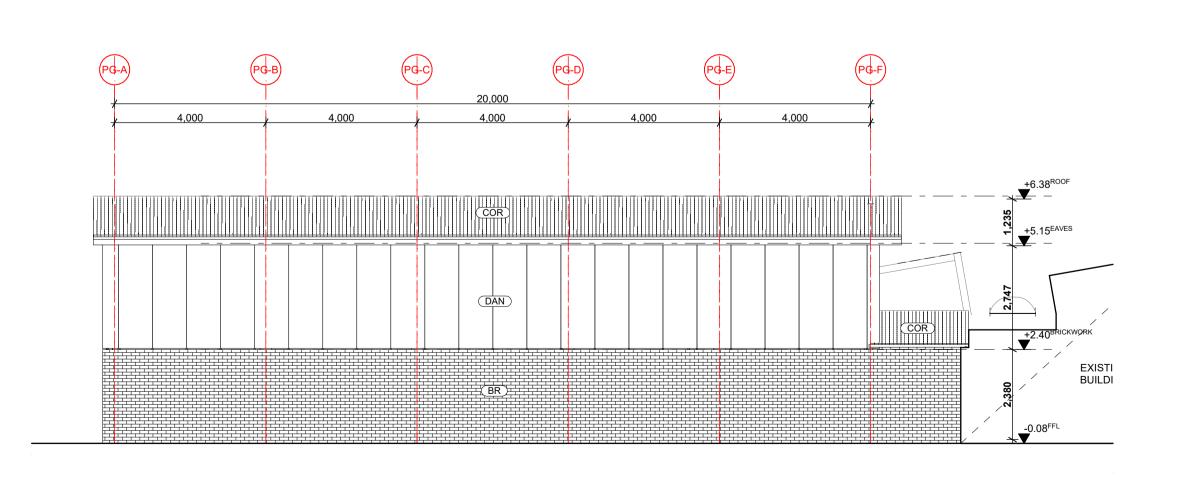






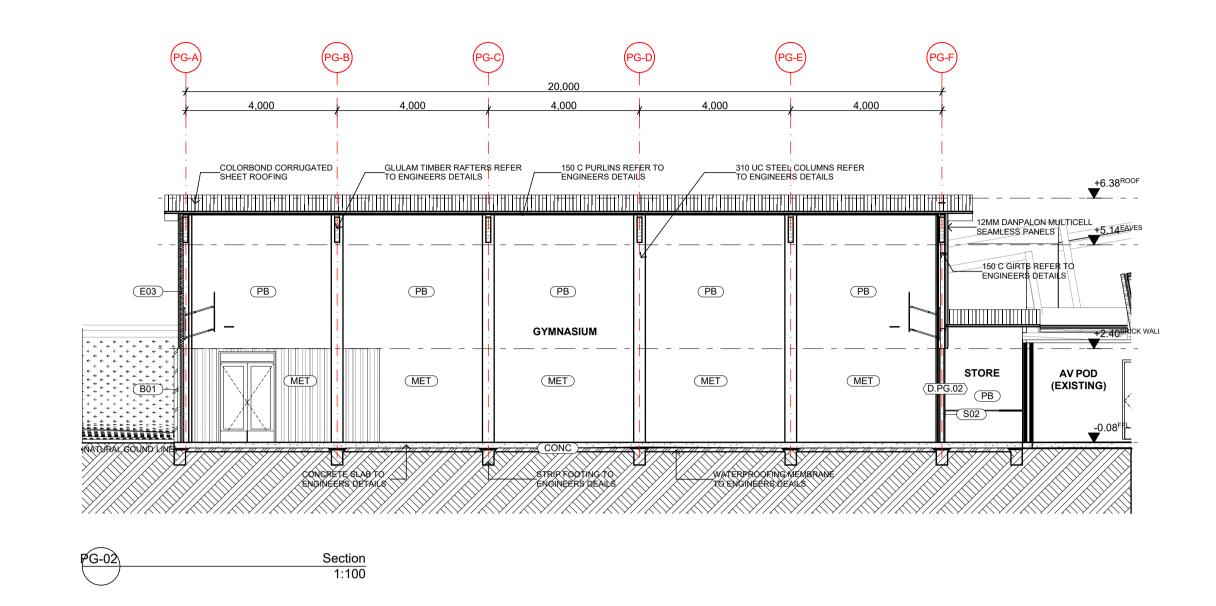

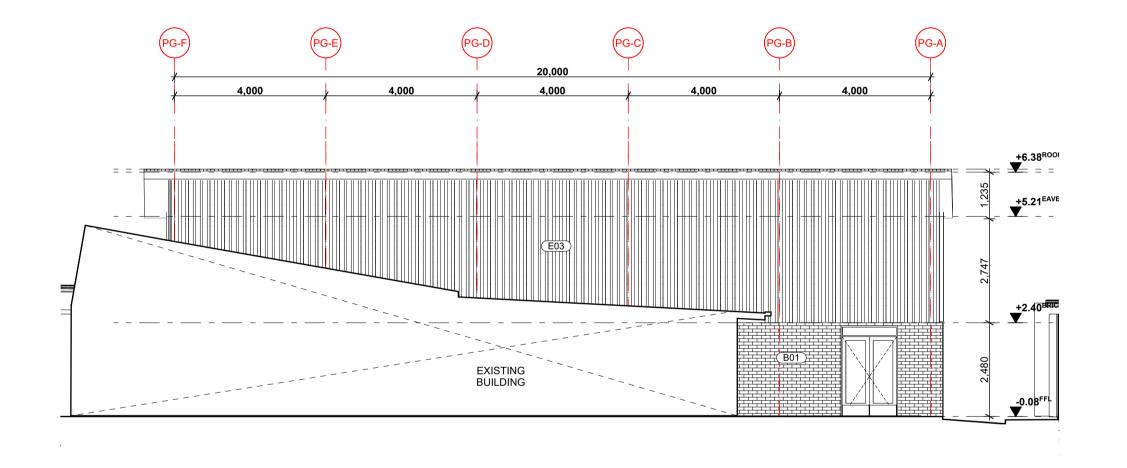
NORTH ELEVATION 1:100

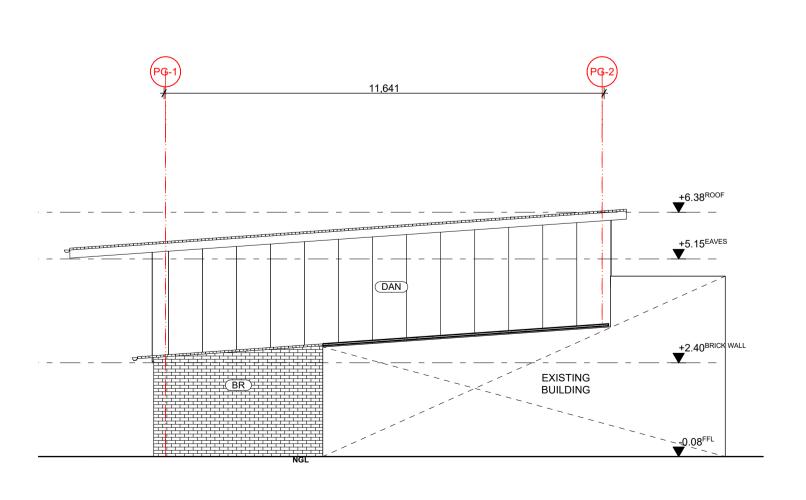





EAST ELEVATION

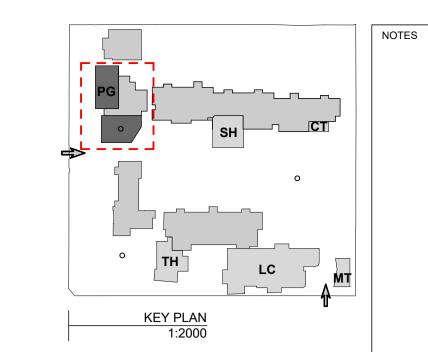

REV	DATE	BY	CH	DESCRIPTION
01	14/07/2021	JP	JM	DD DESIGN MEETING
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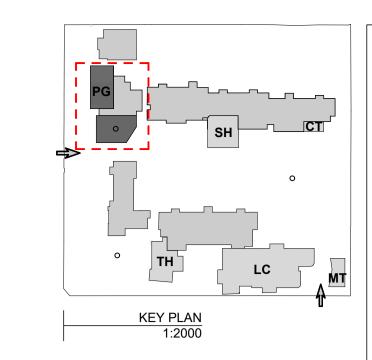
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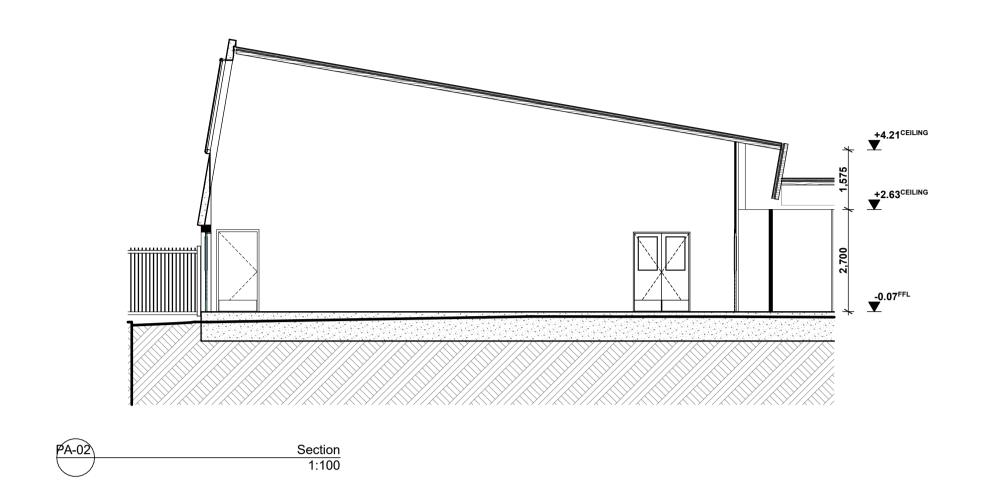
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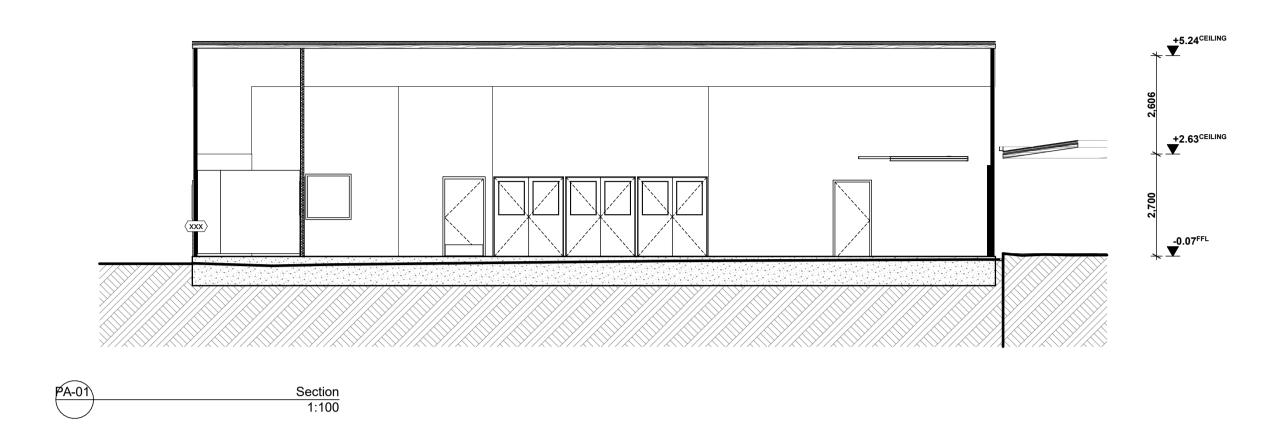
Barwon Valley School - Stage 2


PG Gymnasium Sections & Elevations


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DRAWN	JP	
CHECKED	JM	
PLOT DATE	27/07/2021	
PROJECT	DWG NO.	REV
2105	DD.04.04	03







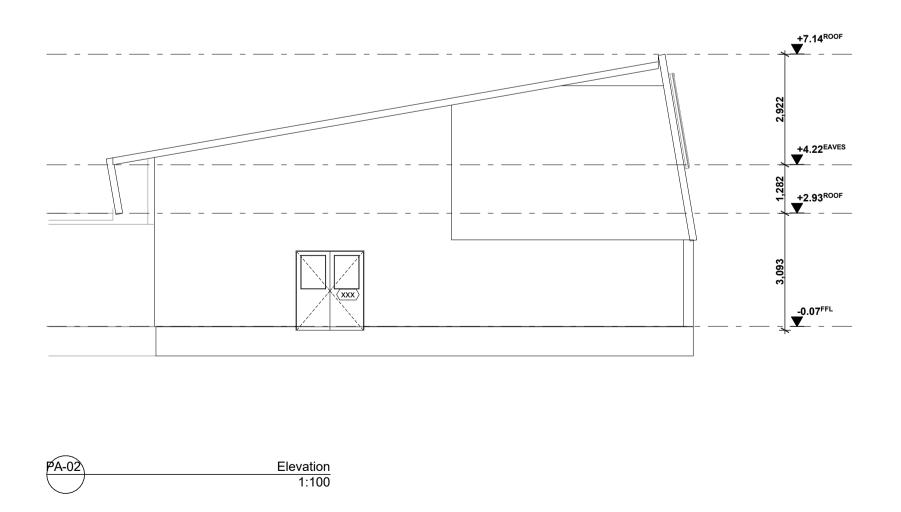

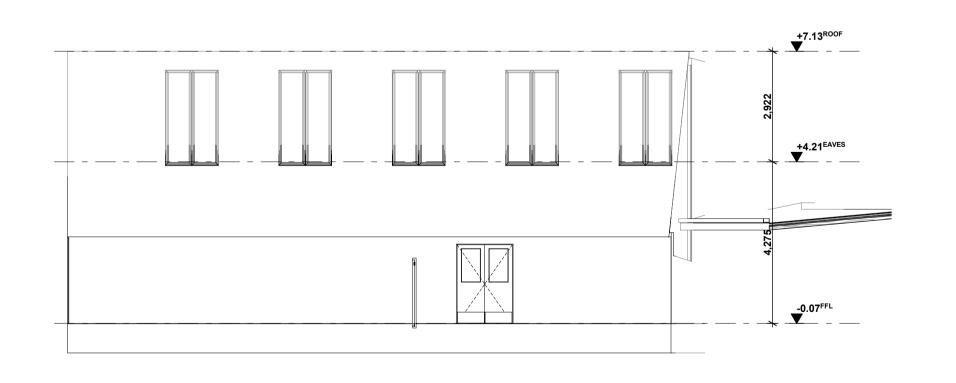



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01	14/07/2021	JP	JM	DD DESIGN MEETING
02	16/07/2021	JP	JM	FOR QS REVIEW
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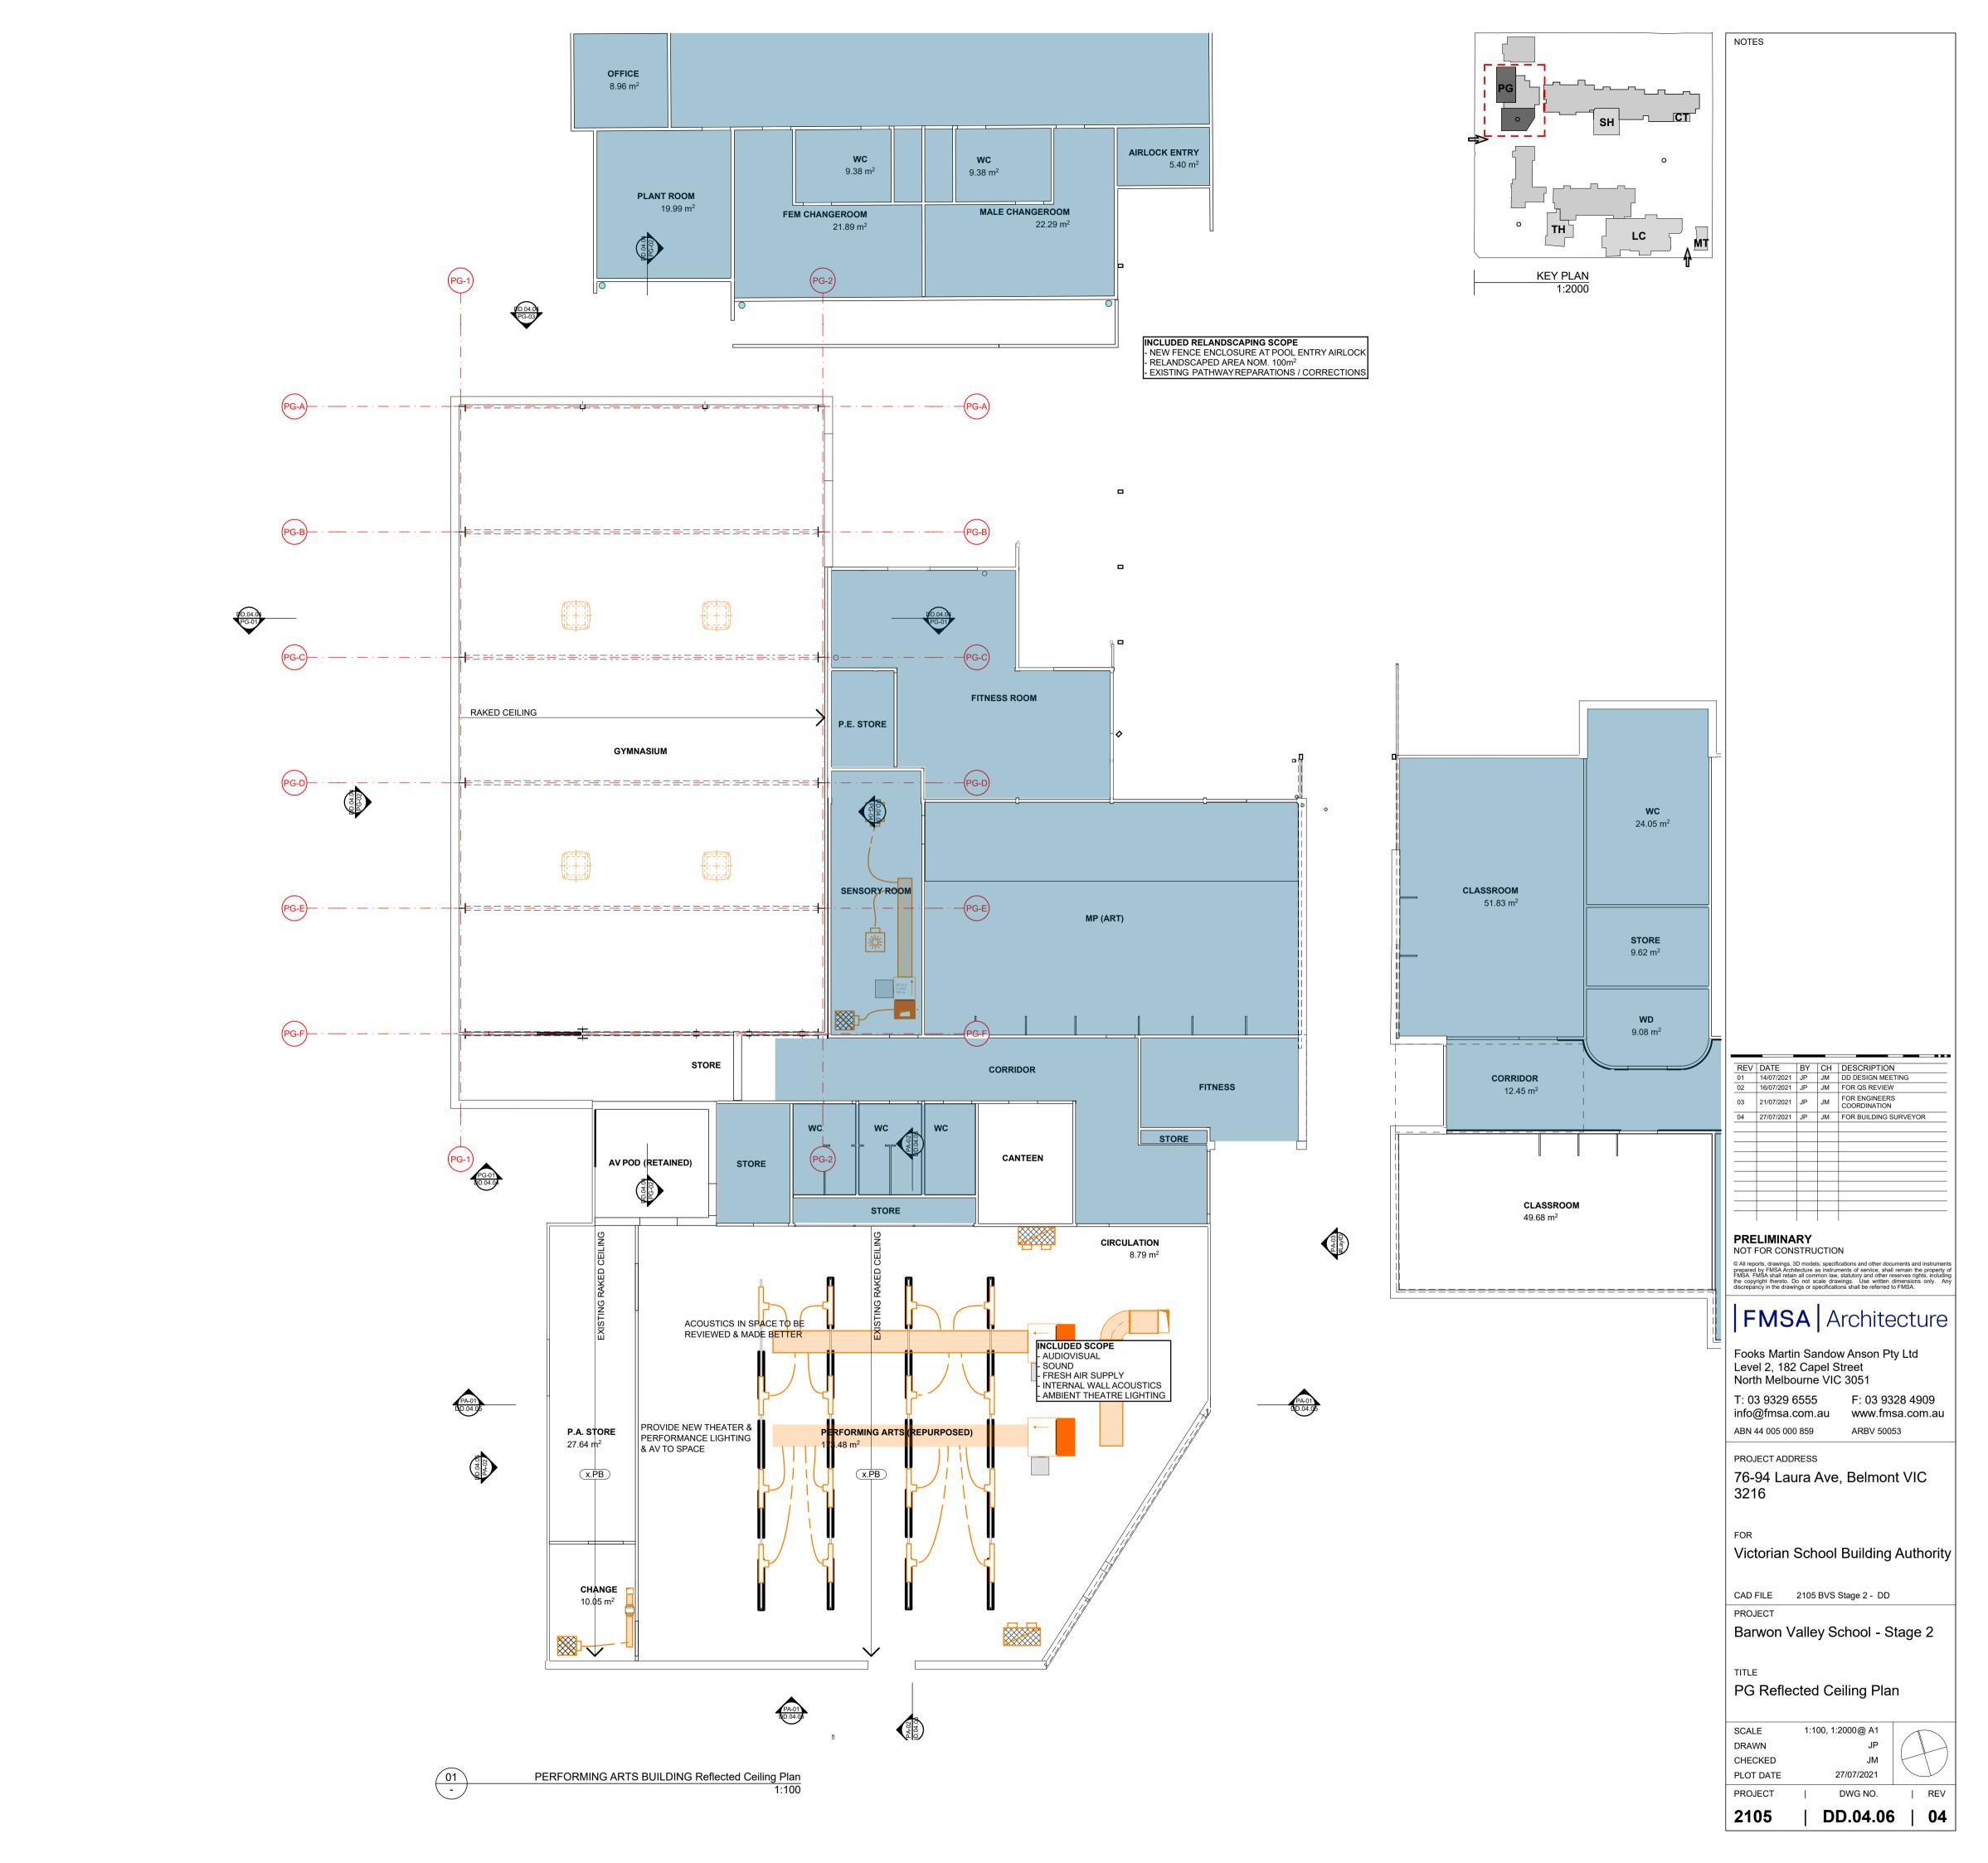
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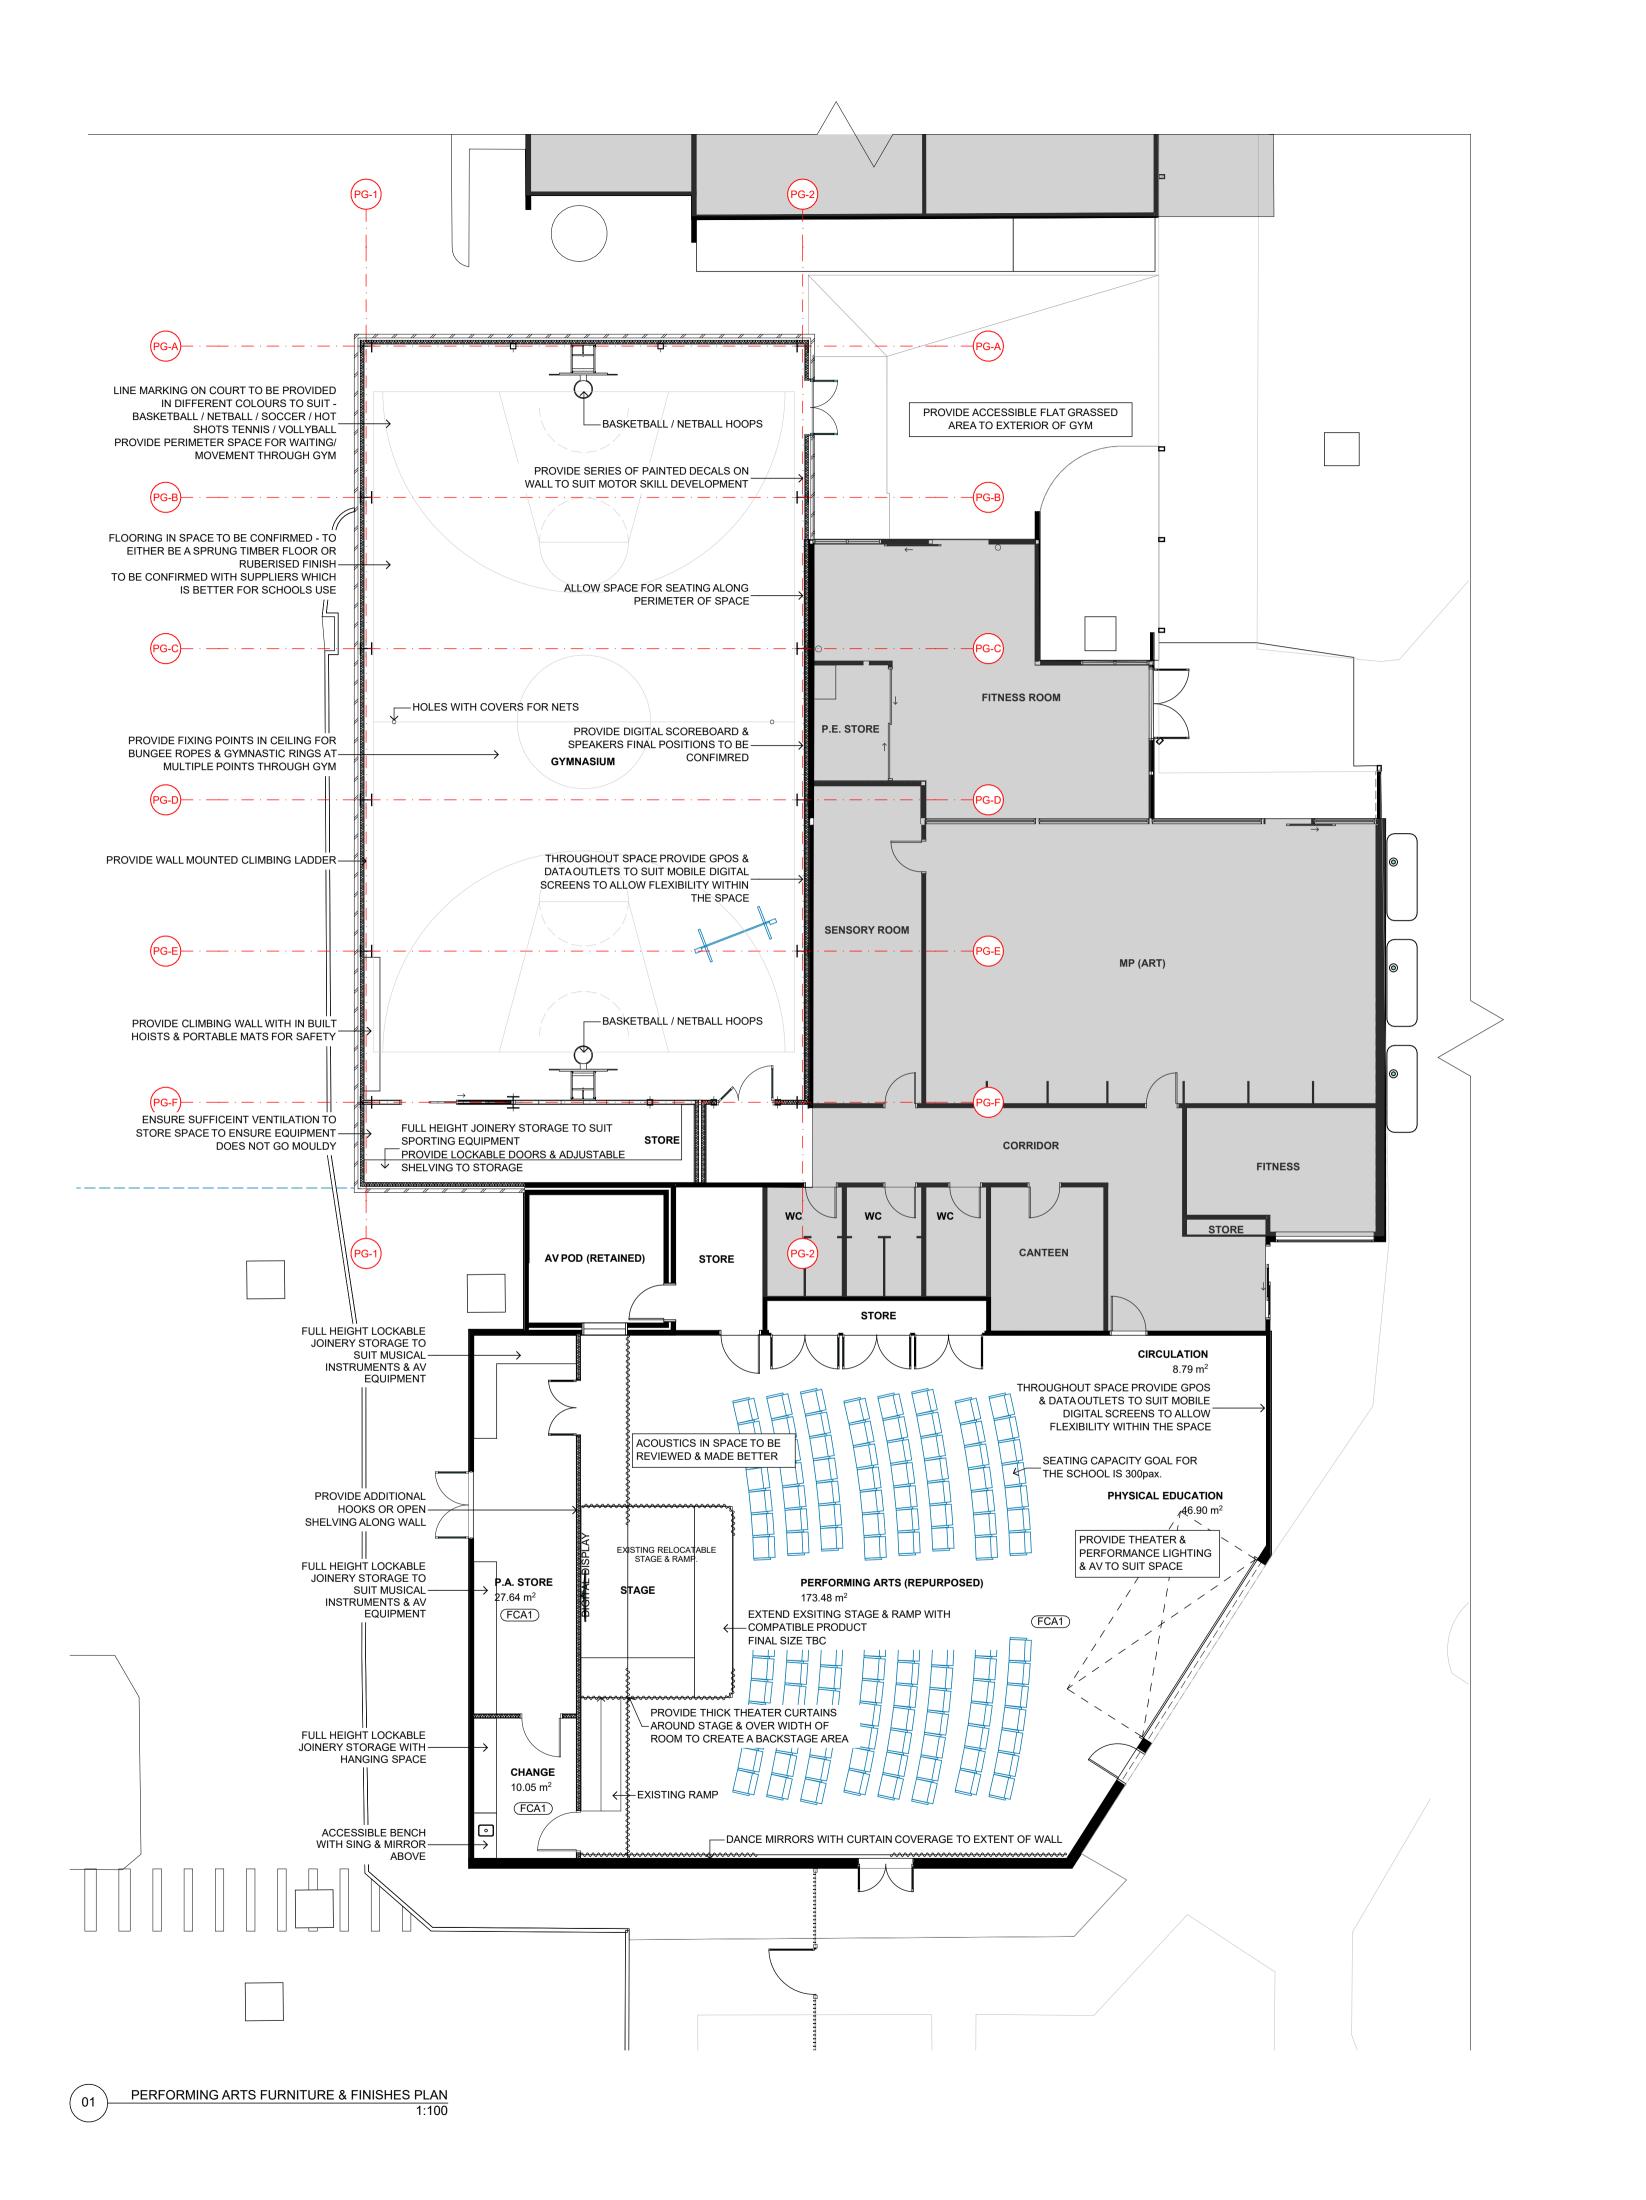
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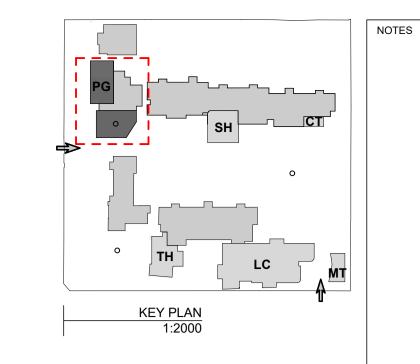
Barwon Valley School - Stage 2

PG Performing Arts Sections & Elevations

2105	DD.04.05	03
PROJECT	DWG NO.	REV
PLOT DATE	27/07/2021	
CHECKED	JM	
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SCALE	1:100, 1:2000@ A1	







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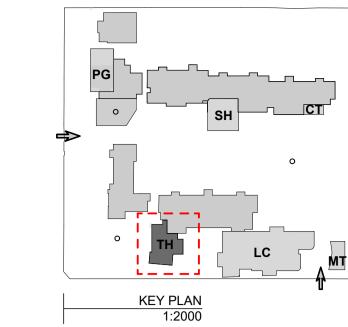
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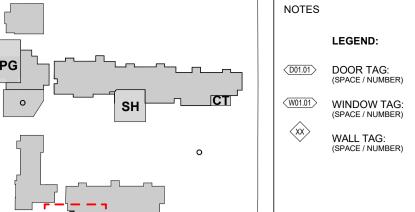
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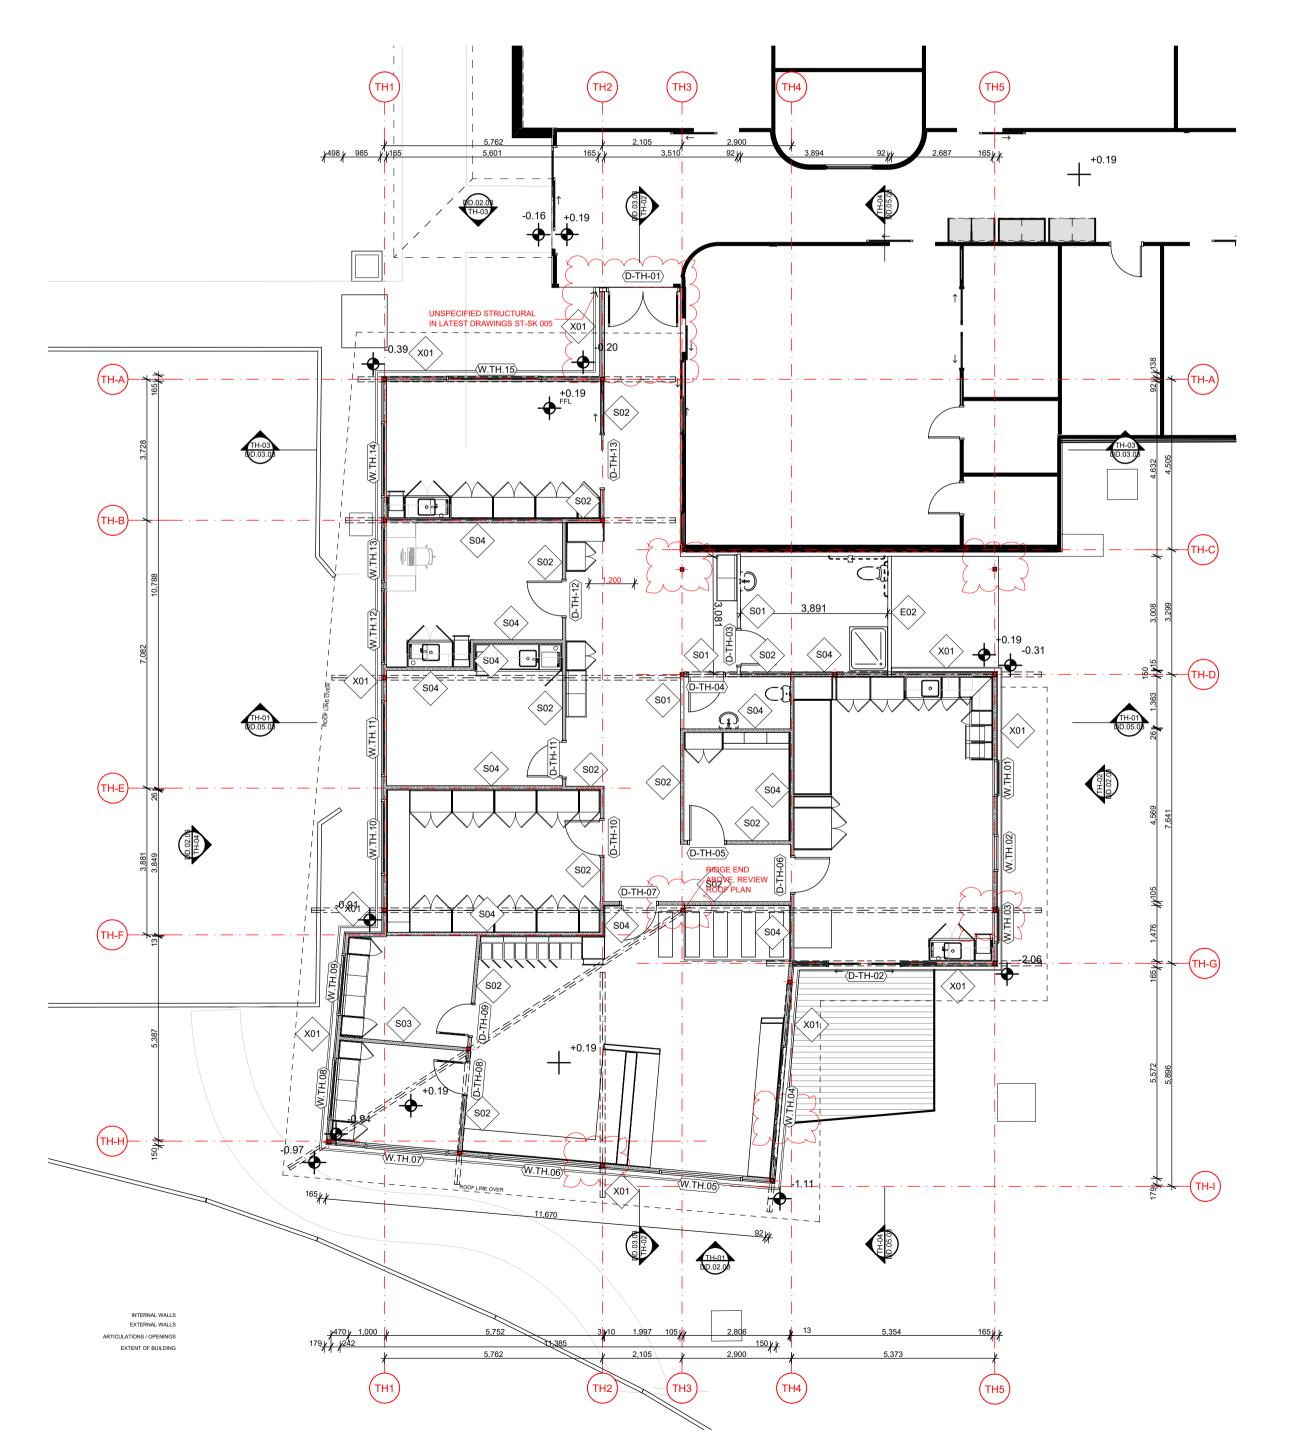
Barwon Valley School - Stage 2


PG Furniture & Finishes Plan

2105		DD.04.07		03
PROJECT	ı	DWG NO.		REV
PLOT DATE		27/07/2021		
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REV	DATE	BY	CH	DESCRIPTION
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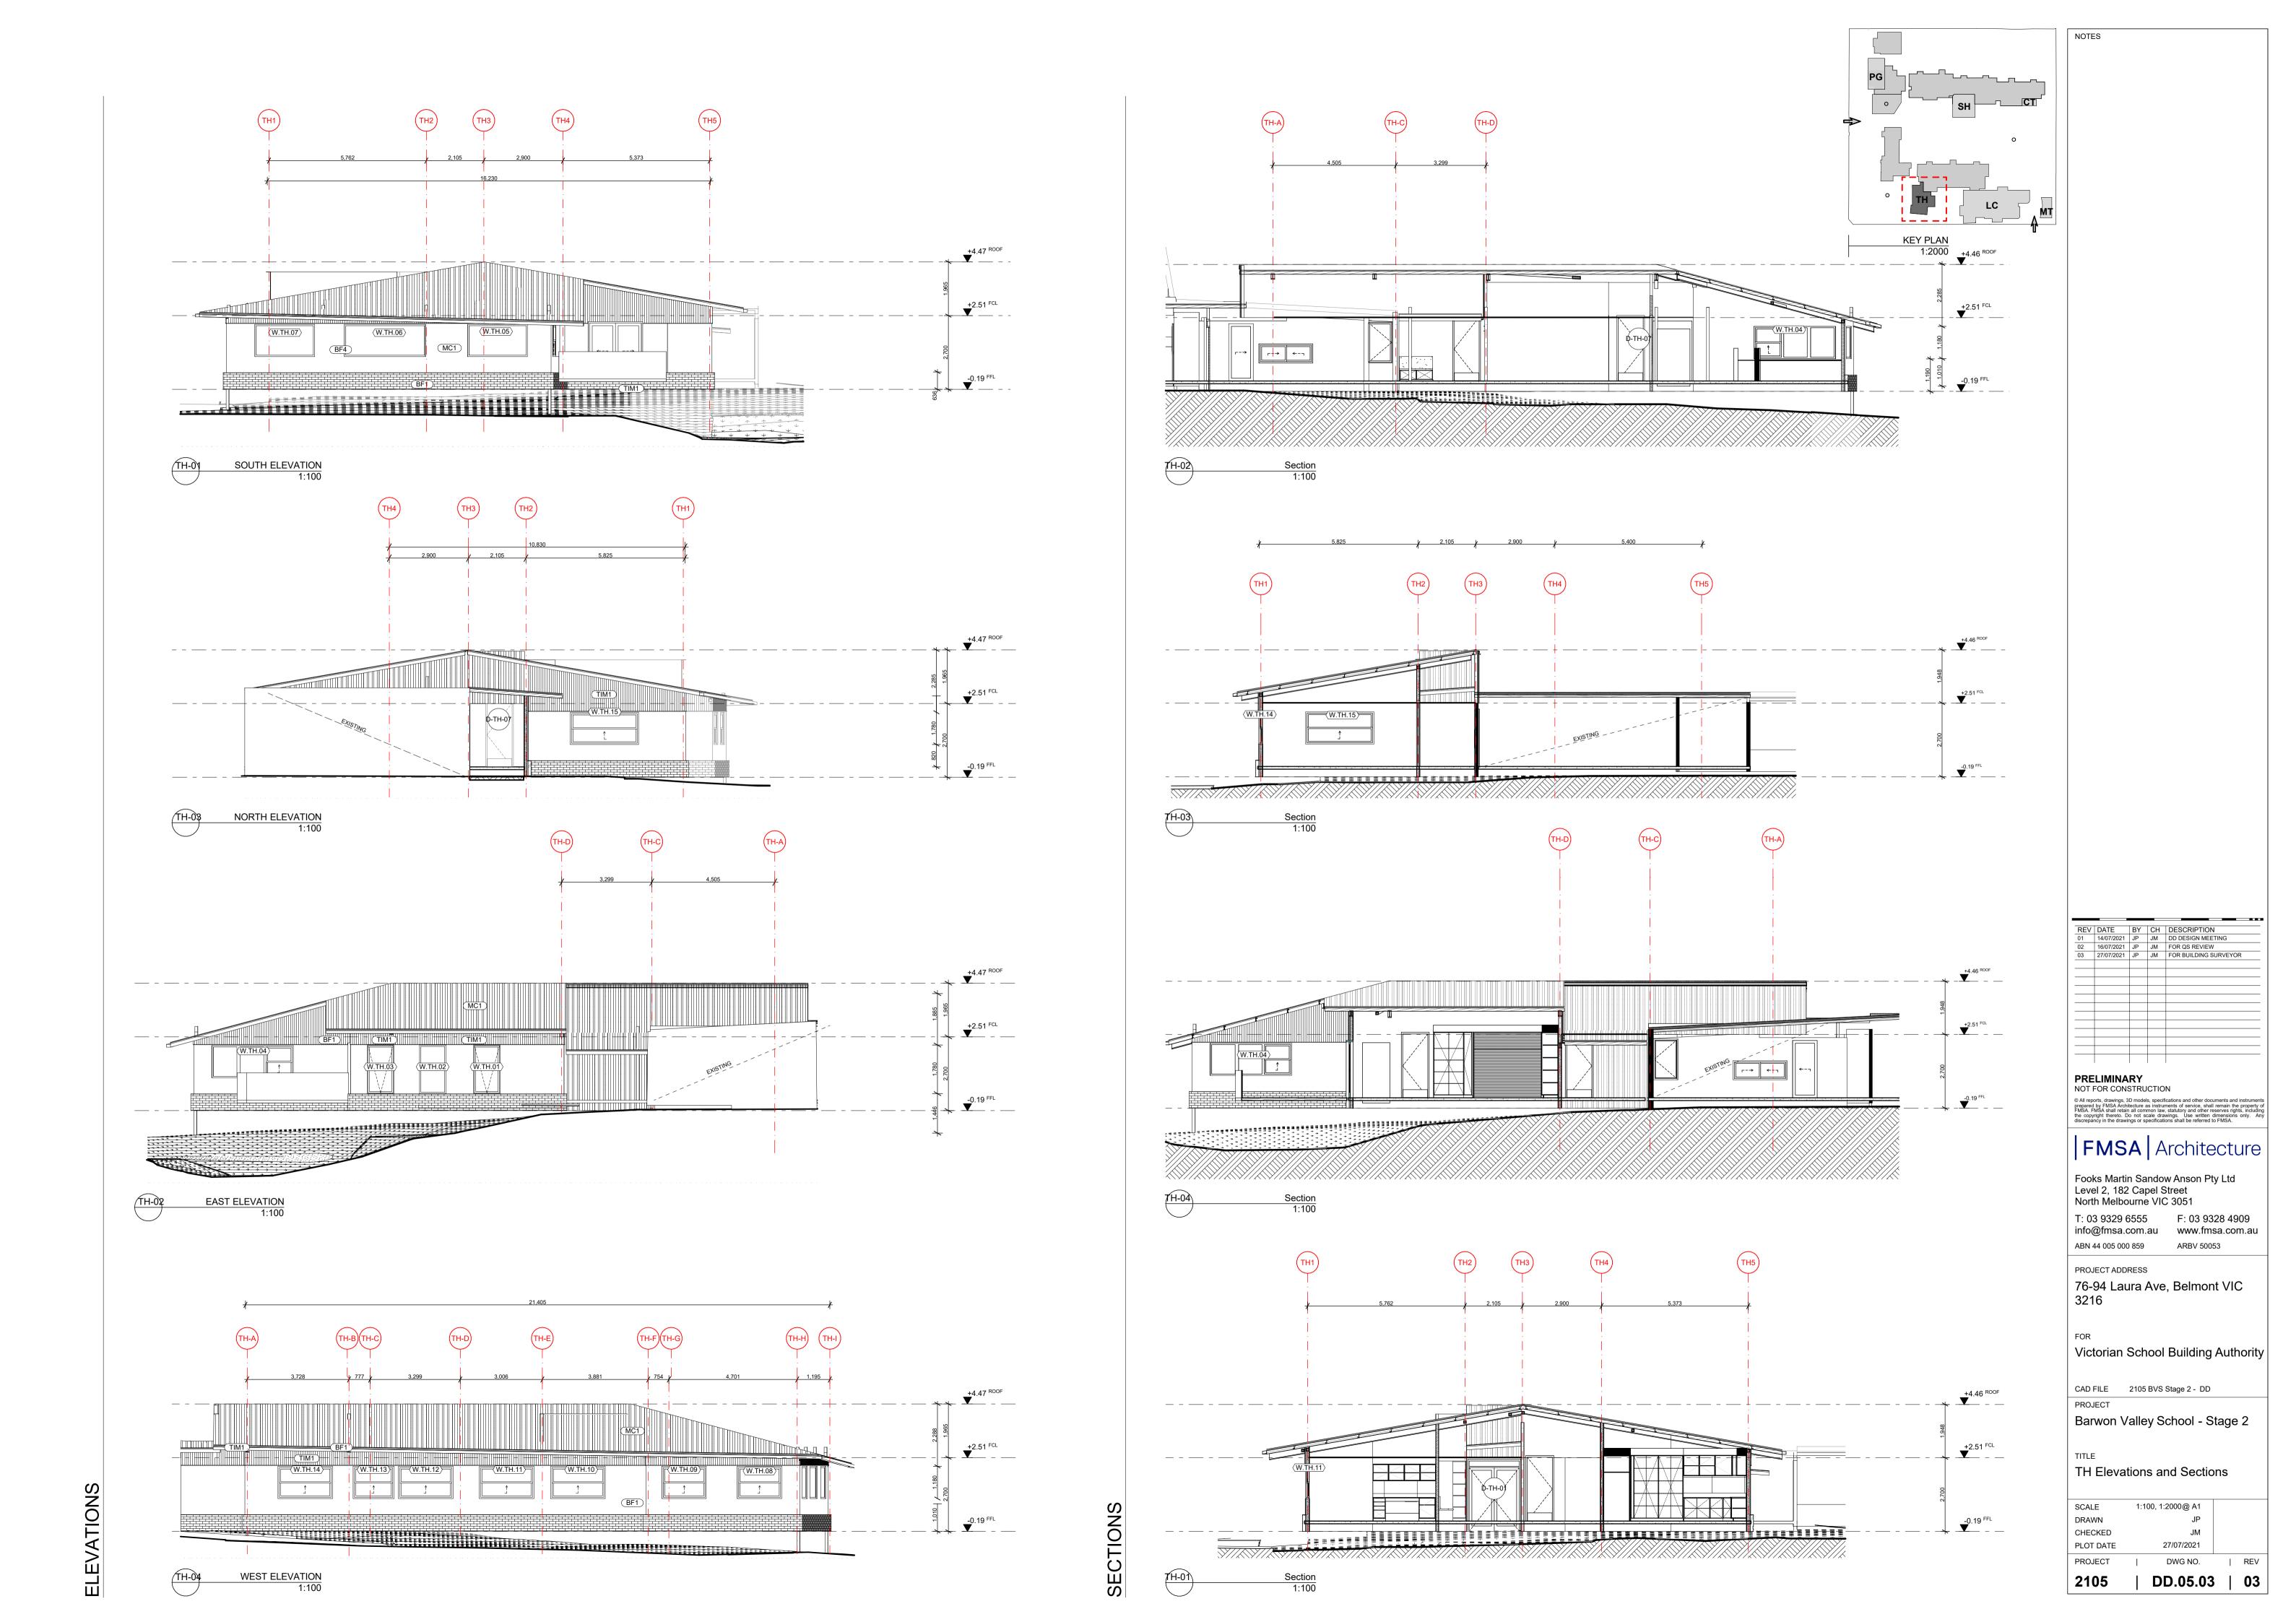
Victorian School Building Authority


CAD FILE 2105 BVS Stage 2 - DD

Barwon Valley School - Stage 2

TITLE TH Plans
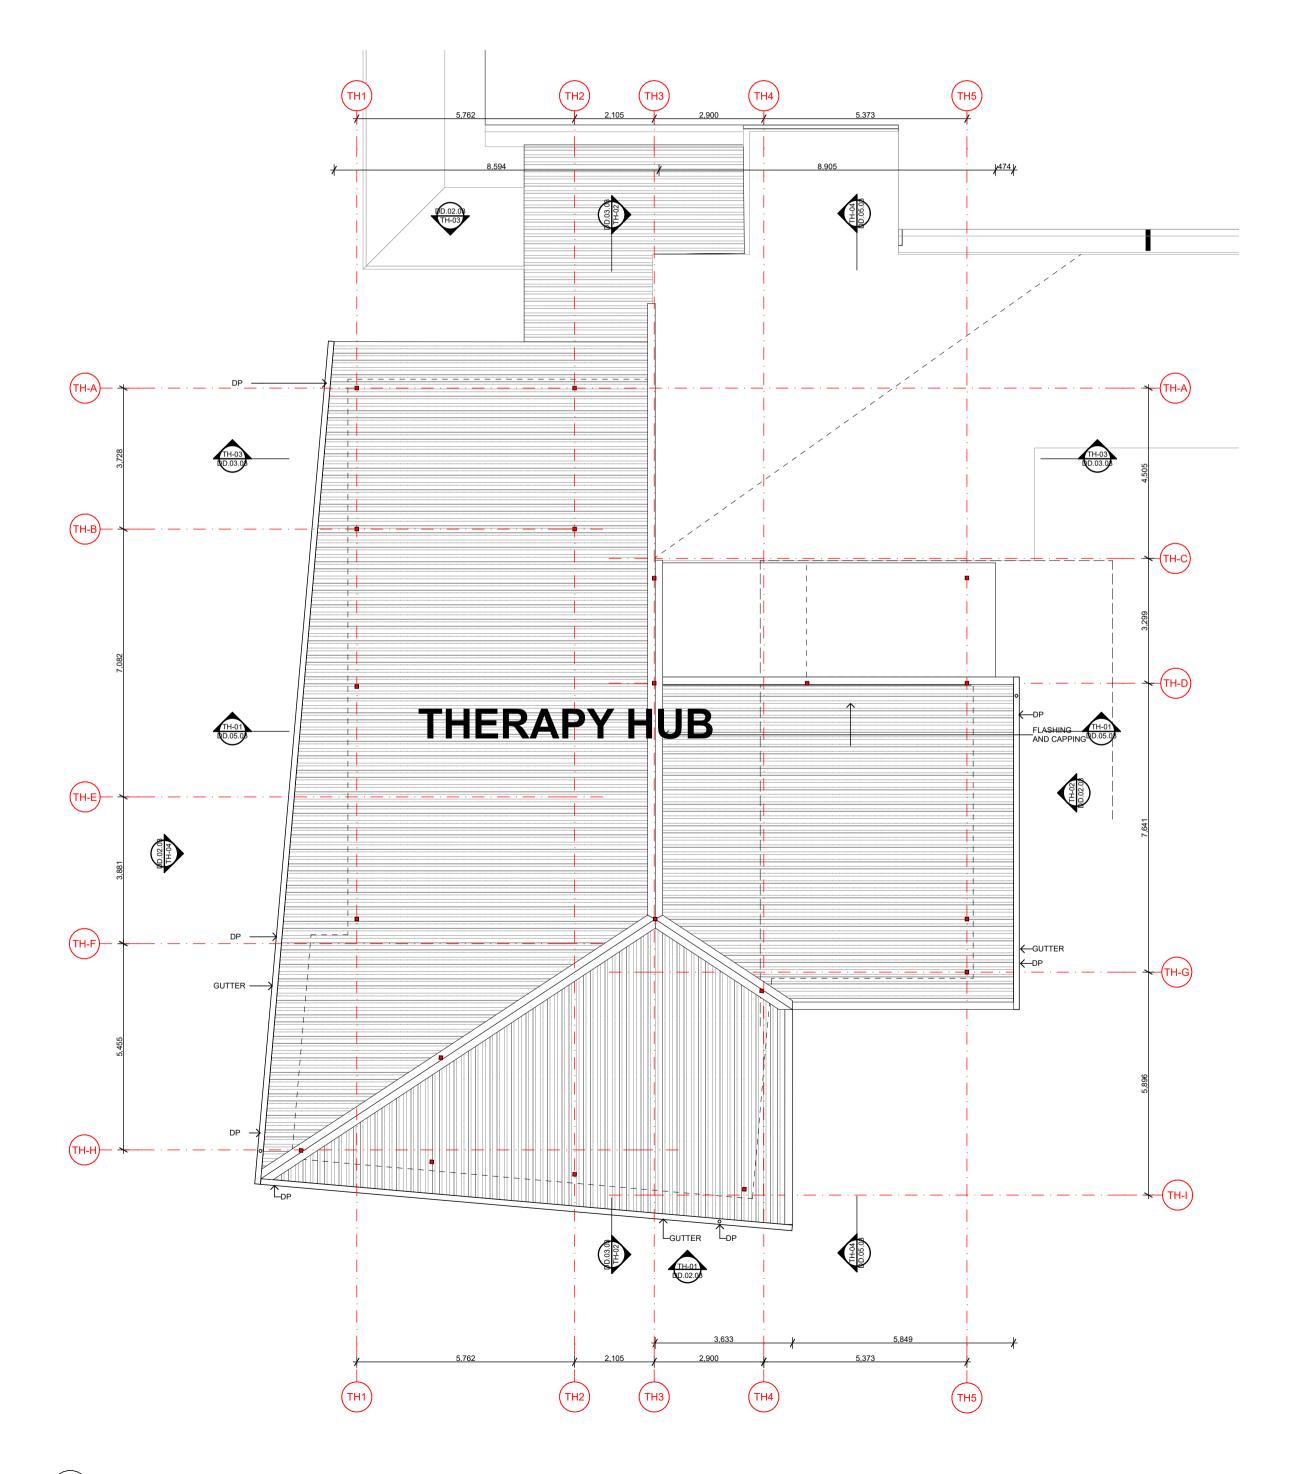
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10.99 m² 10.61 m² 10.61 m²	TH1)	TH2 TH3	WD 9.07 m ²	TH5	
	TH-03	12.90 Q =	(0.50.0) (0.50.0)	STORE &	Σ _E TH
TH-A	FIRST AID		THERAPY 52.69 m ²	9.88 m ²	7H-O3 100.03.04
TH-B	MEETING A 16.21 m ² APB	CIRCULATION	DDA WC PB 11,99 m ²		· ·(TH-C)
TH-01 0.05.06	CH 2720 APB MEETING B CH 2720 15.84 m ²	43.95 m ² WC 3.83 m ² PB CH 2720	CH 2720		TH-D 1005.96
TH-E	RAKED CEILING RESOURCE ROOM 21.40 m ² APB	MEETING 8.16 m² (APB) (CH 2720	INFORMAL CONS	SULTATION	
TH-F	STAFF 68.26 m ²	COMPACTUR 2 4.14 m ²	720 DECK		· ·TH-G
TH-H	APB ROOF LINE OVER	AAKED CEILING	14.64 m ²		— · — (TH-I)
		(SO) (TH-01) (ND.020)	1 H-04		
	TH1	TH2 TH3	TH4	TH5	

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 FOR QS REVIEW

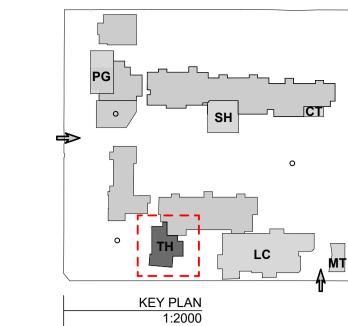 03
 21/07/2021
 JP
 JM
 FOR ENGINEERS COORDINATION

 04
 27/07/2021
 JP
 JM
 FOR BUILDING SURVEYOR

NURSE OFFICE STORE INCLUSIONS
- LOCKABLE MEDICAL SUPPLIES STORAGE
- REFRIGERATION
- LOCKABLE MEDICATION STORAGE

WELLBEING STORE INCLUSIONS
- ADDITIONAL CLOTHING / UNIFORMS
- BREAKFAST FOOD / UTENSILS STORE

- MATERIALS - COUNTING SCALES

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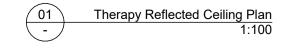
Victorian School Building Authority


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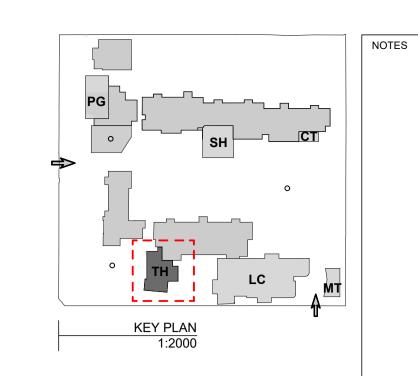
Barwon Valley School - Stage 2

TH Reflected Ceiling Plan

SCALE 1:100, 1:2000@ A1 DRAWN CHECKED JM PLOT DATE 27/07/2021 PROJECT DWG NO. 2105 DD.05.04 | 04





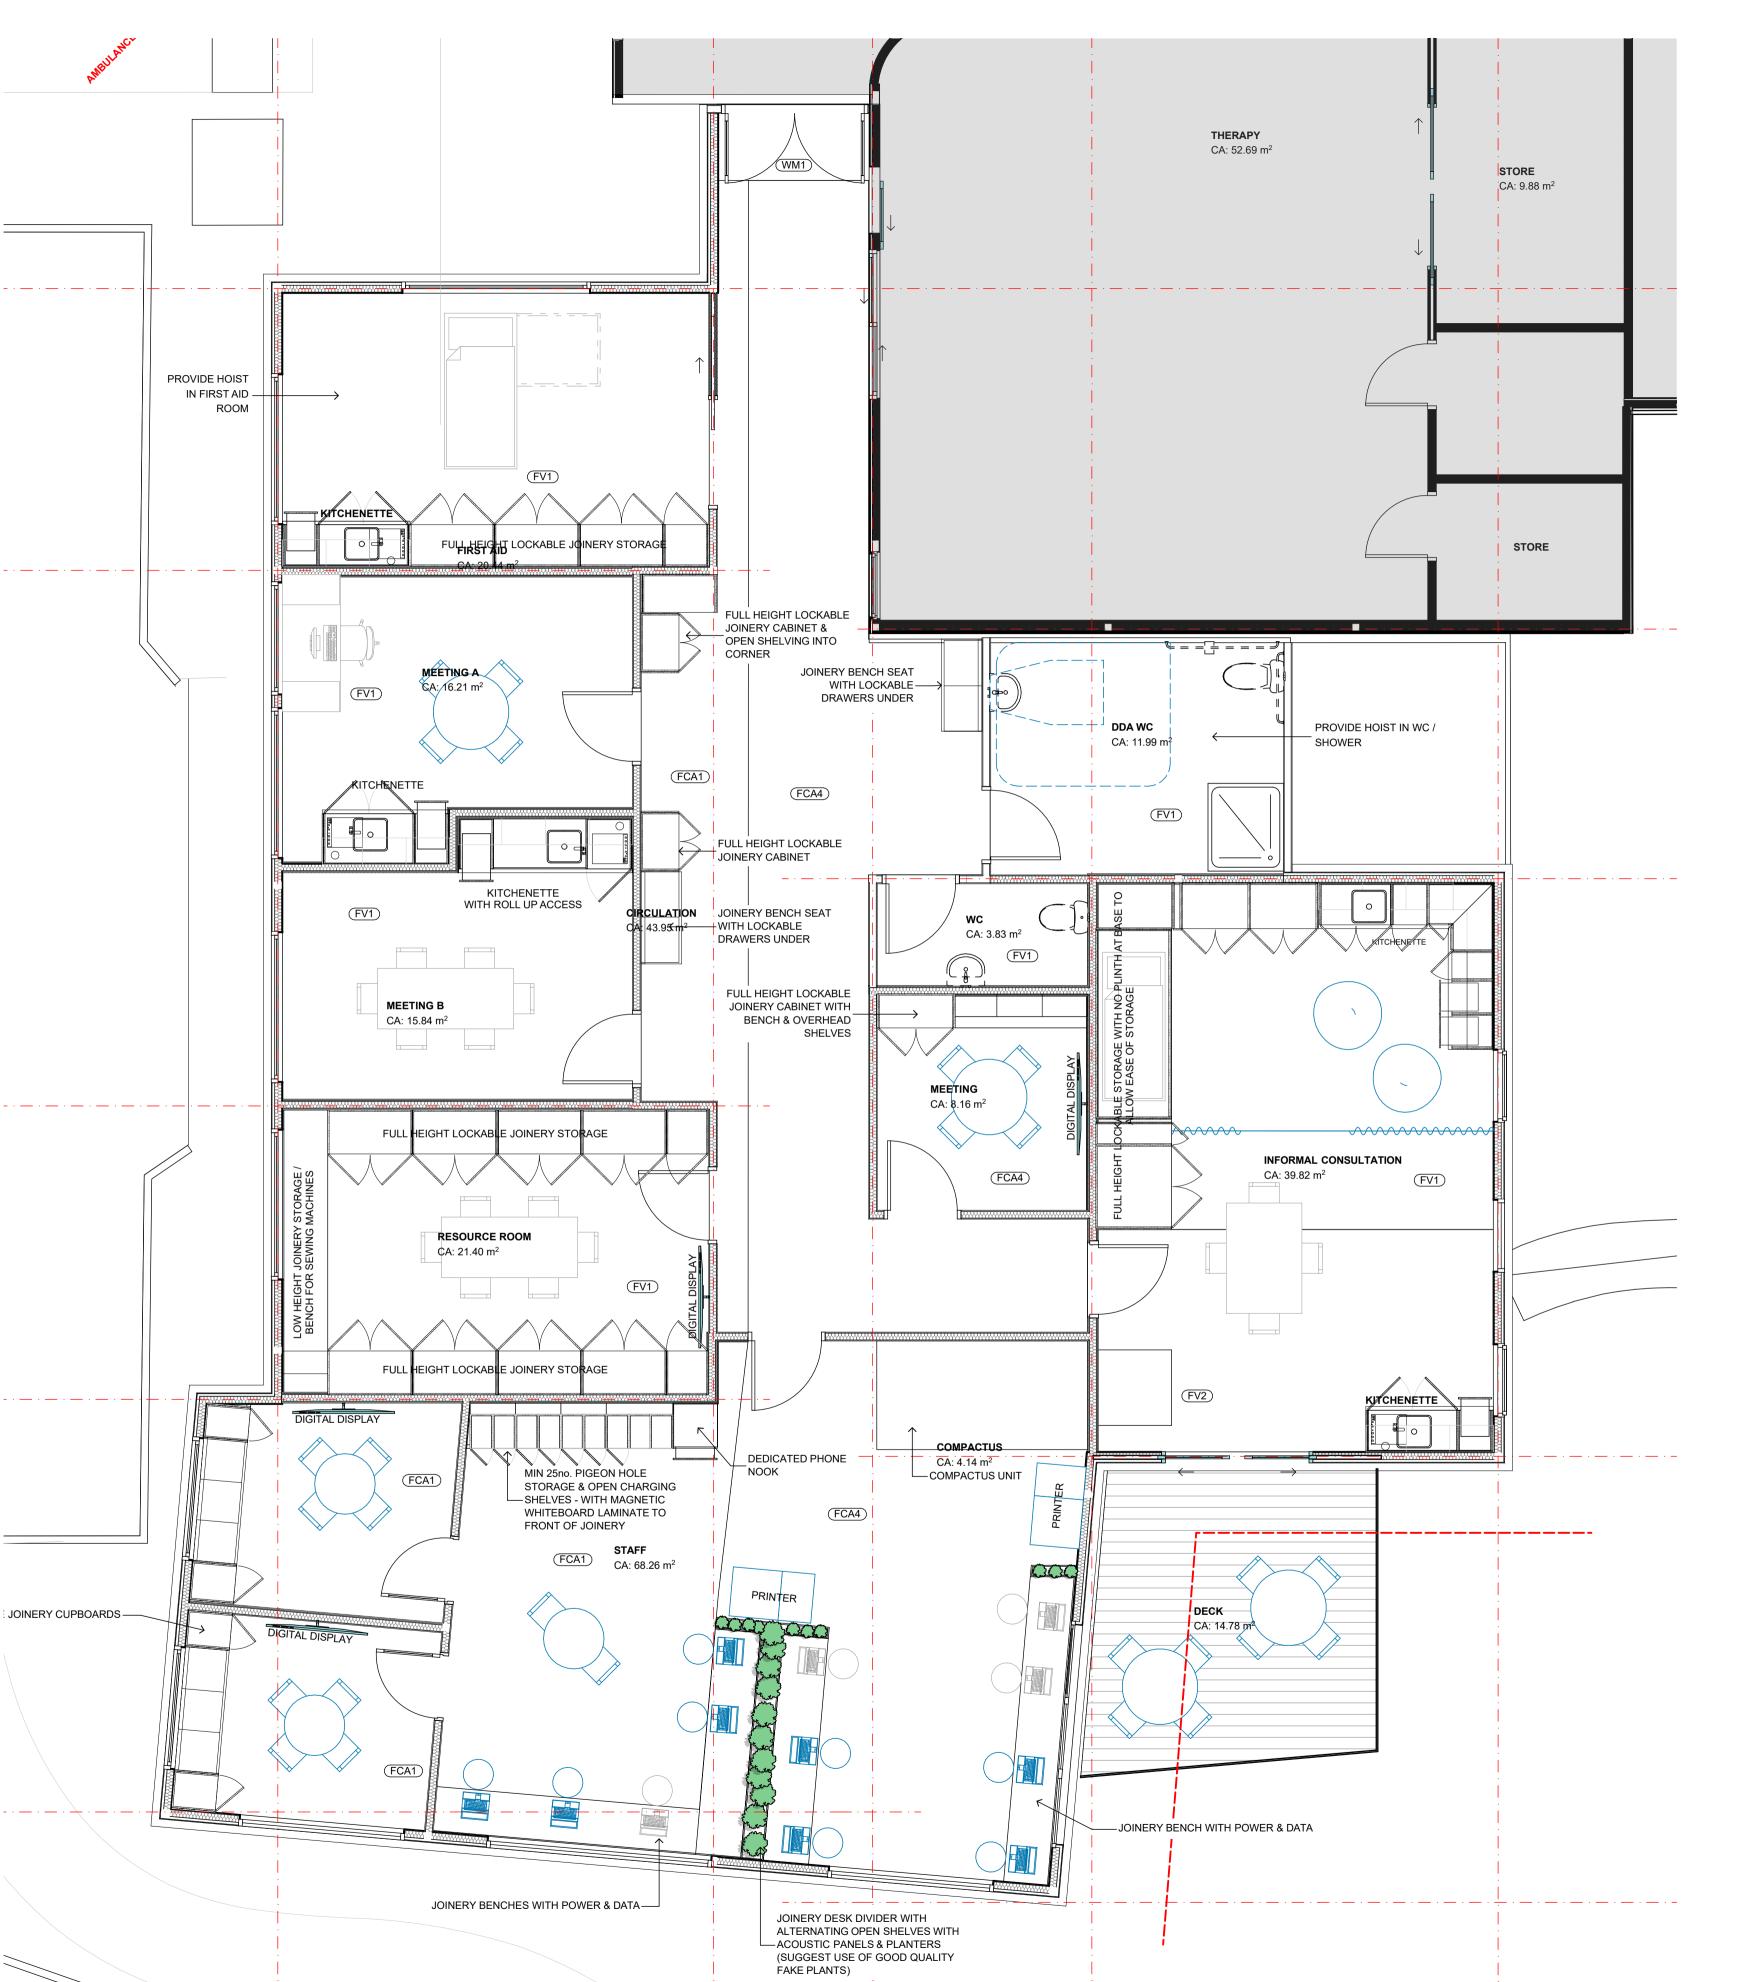

PROPOSED FINISHES

METRO GREY

FV1: SHEET VINYL

CAMDEN GREY






METRO MOSS


FV2: SHEET VINYL

MOSSMAN

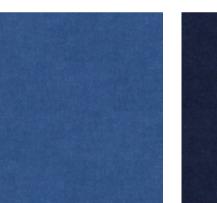



FCA4: FLOCKED CARPET METRO INDIGO

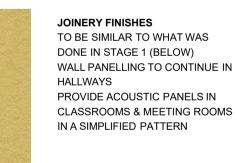





PIN1: PINBOARD



REV	DATE	BY	СН	DESCRIPTION
01	14/07/2021	AJ	JM	DD DESIGN MEETING
02	16/07/2021	AJ	JM	FOR QS REVIEW
03	27/07/2021	AJ	JM	FOR BUILDING SURVEYOR

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info@fmsa.com.au www.fmsa.com.au ABN 44 005 000 859 ARBV 50053

PROJECT ADDRESS

76-94 Laura Ave, Belmont VIC

Victorian School Building Authority


CAD FILE 2105 BVS Stage 2 - DD PROJECT


Barwon Valley School - Stage 2


TH Furniture & Finishes Plan 1:50, 1:2000@ A1


SCALE DRAWN CHECKED PLOT DATE 27/07/2021 PROJECT DWG NO. 2105 DD.05.05 | 03




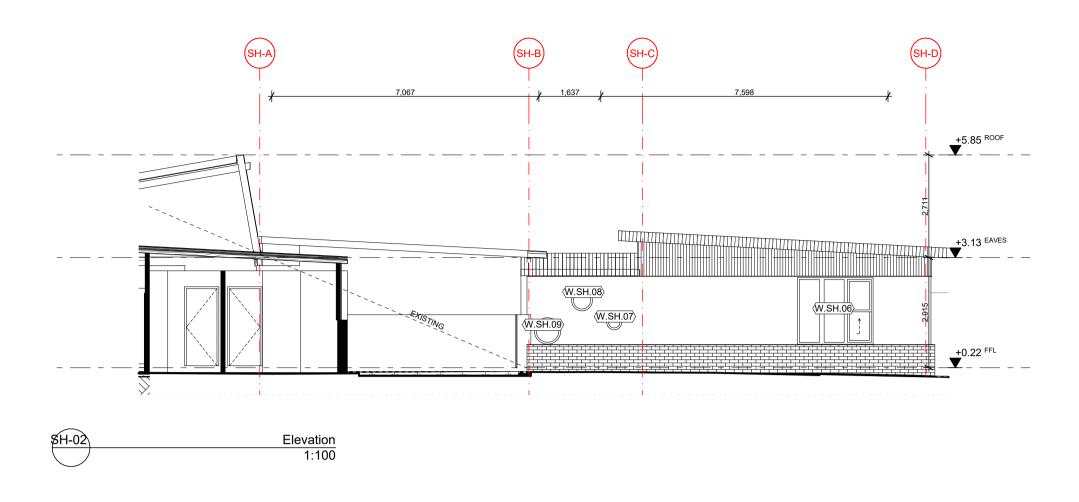

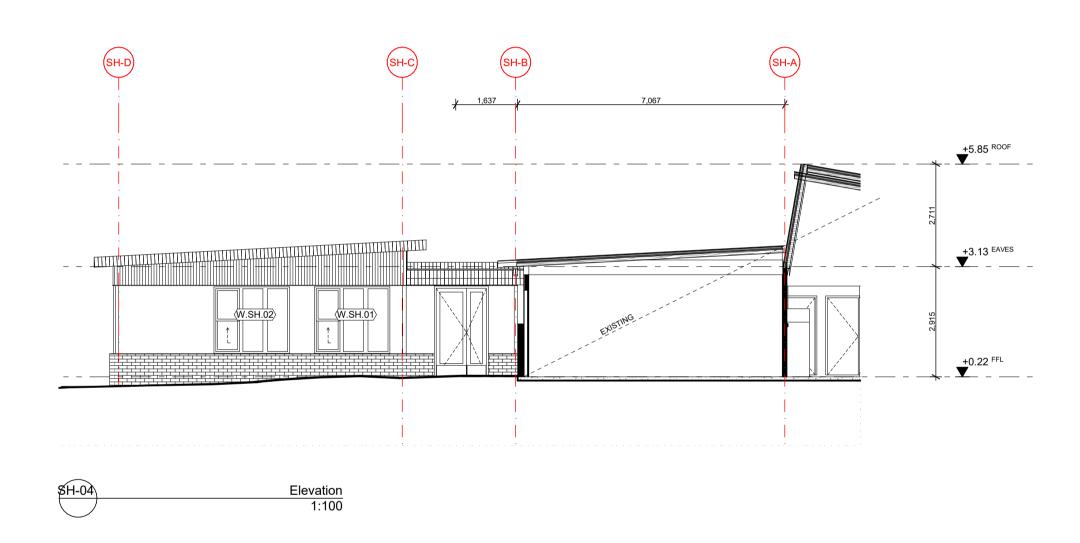

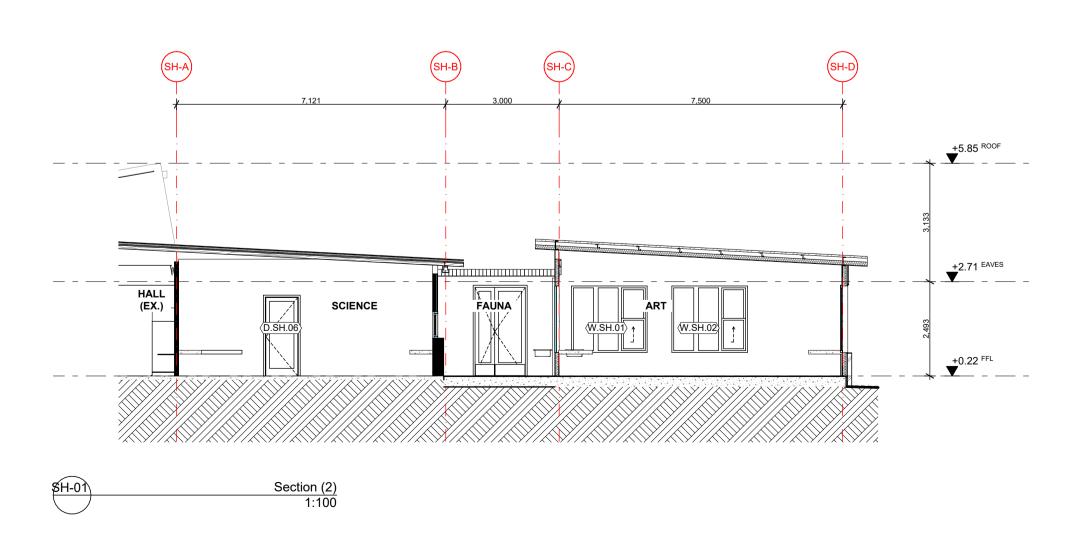

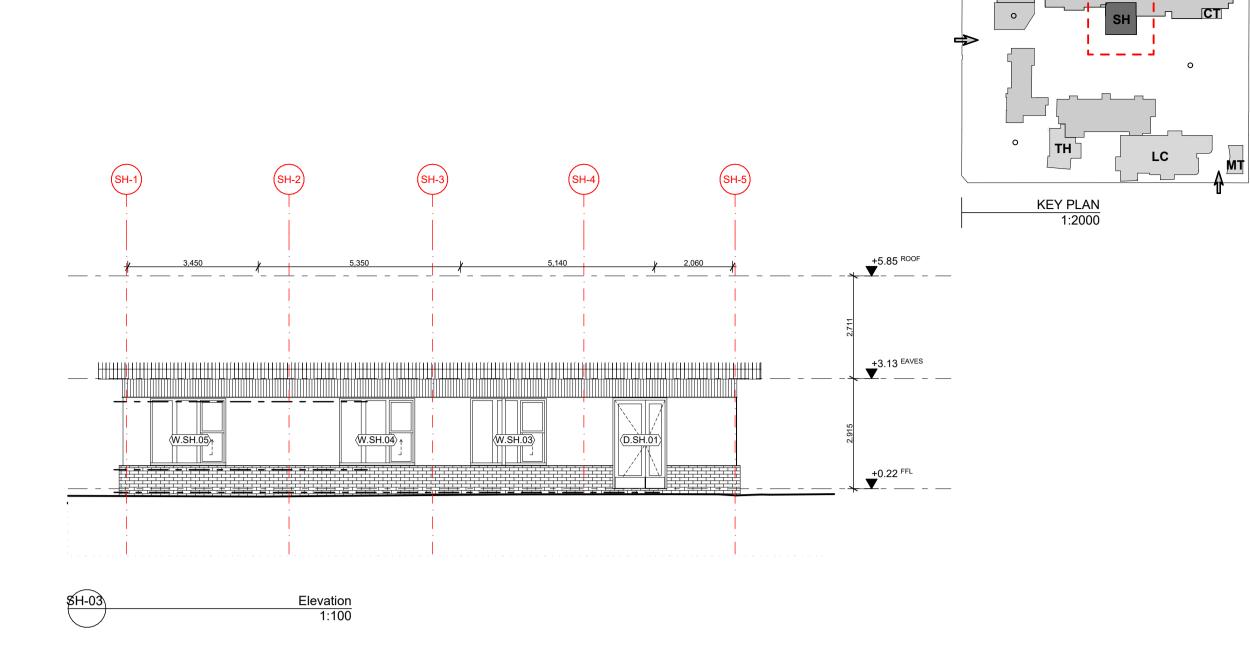

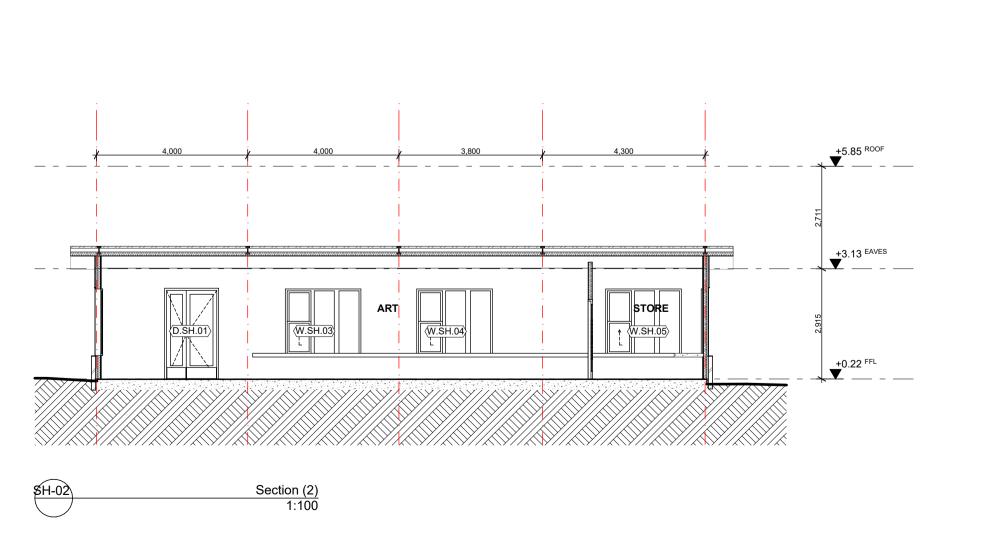

REV	DATE	BY	СН	DESCRIPTION
01	14/07/2021	JP	JM	DD DESIGN MEETING
		_		
02	16/07/2021	JP	JM	FOR QS REVIEW
03	27/07/2021	JP	JM	FOR BUILDING SURVEYOR

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PROJECT ADDRESS

76-94 Laura Ave, Belmont VIC 3216

Victorian School Building Authority

CAD FILE 2105 BVS Stage 2 - DD Barwon Valley School - Stage 2

SH Elevations and Sections

2105	DD.06.02		03
PROJECT	DWG NO.		REV
PLOT DATE	27/07/2021		
CHECKED	JM		
DRAWN	JP		
SCALE	1:100, 1:2000@ A1		





FV1: SHEET VINYL

CAMDEN GREY


FV2: SHEET VINYL

MOSSMAN

PIN1: PINBOARD

FRESH PINEAPPLE

IN A SIMPLIFIED PATTERN

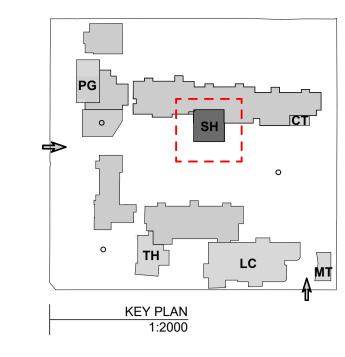

NOTES

 REV
 DATE
 BY
 CH
 DESCRIPTION

 01
 14/07/2021
 AJ
 JM
 DD DESIGN MEETING

 02
 16/07/2021
 AJ
 JM
 FOR QS REVIEW

 03
 27/07/2021
 AJ
 JM
 FOR BUILDING SURVEYOR

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PROJECT ADDRESS

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ARBV 50053


Victorian School Building Authority

CAD FILE 2105 BVS Stage 2 - DD

PROJECT Barwon Valley School - Stage 2

SH Furniture & Finsihes Plan

2105	DD.06.04	
PROJECT	l DWG NO.	l REV
PLOT DATE	27/07/2021	
CHECKED	JM	
DRAWN	JP	
SCALE	1:50, 1:2000@ A1	
		Ι

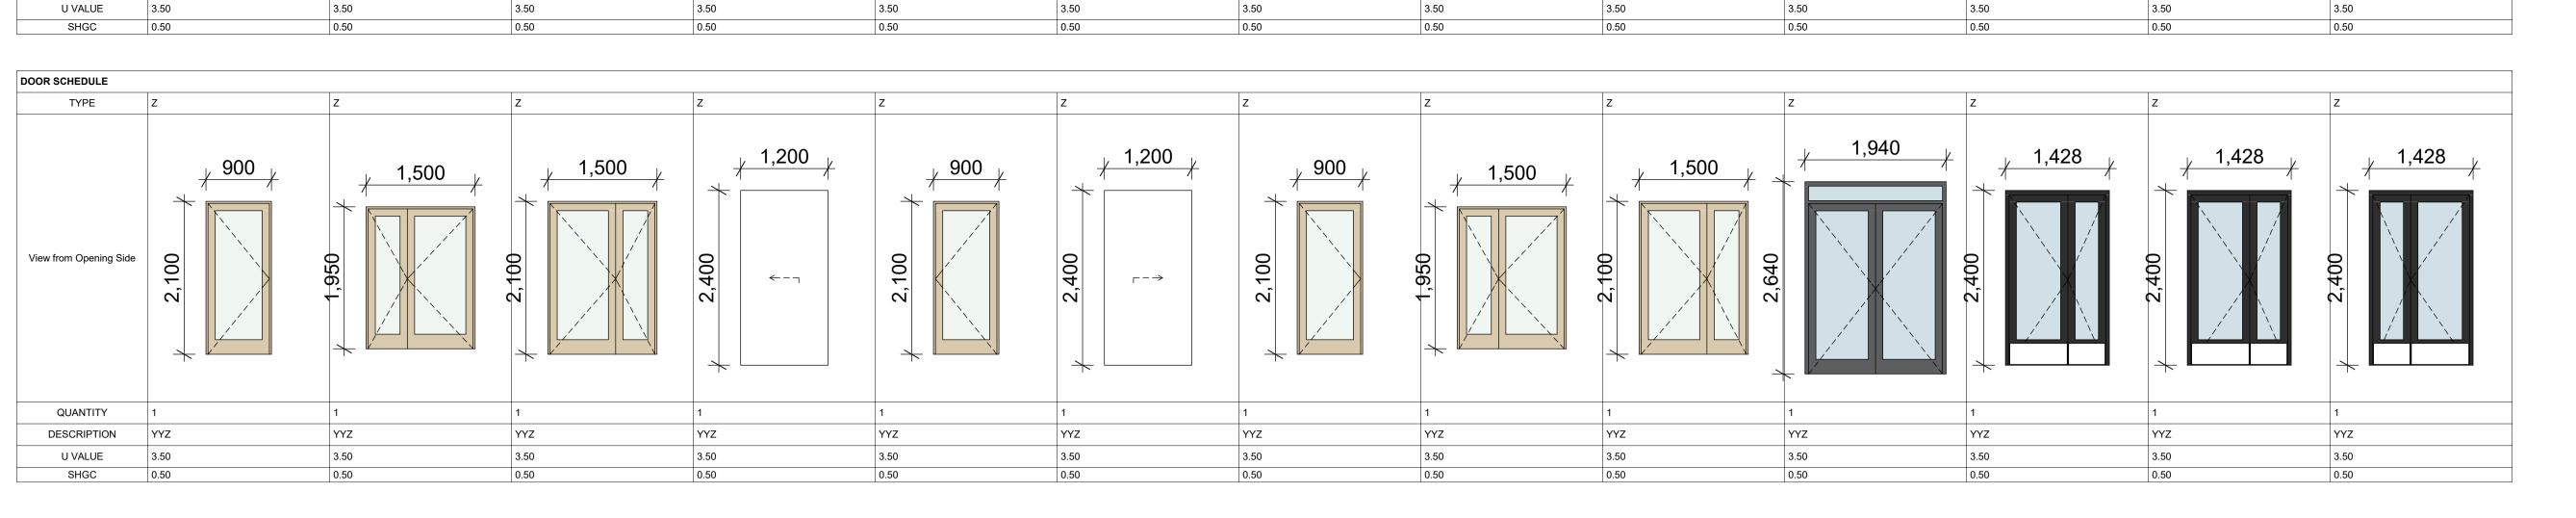

0. FMSA Door List

D.LC.02

D.LC.03

D.LC.04

D.LC.05

D.LC.06

D.LC.07

D.LC.08

D.LC.09

D.LC.10

D.LC.11

D.LC.15

D.LC.16

D.LC.17

D.LC.18

D.LC.19

D.LC.20

D.LC.21

D.LC.22

D.LC.23

D.LC.24

D.LC.25

D.LC.27

D.LC.28

D.LC.29

D.LC.30 D.LC.31

D.LC.32

D.LC.33

D.LC.34

D.LC.35

D.LC.36

D.LC.37

D.LC.39

D.LC.40

D.LC.41

D.LC.42

D.LC.43

D.LC.45

D.LC.46

D.MT.01

D.MT.02

D.PG.01

D.PG.02

D.PG.03

D.PG.05

D.PG.06

D.PG.07

D.SH.01

D.SH.02

D.SH.02

D.SH.03

D.SH.04

D.SH.06

D.SH.07

D-TH-01

D-TH-02

D-TH-03

D-TH-04

D-TH-05

D-TH-06

D-TH-07

D-TH-08

D-TH-09

D-TH-10

D-TH-11

D-TH-12

D-TH-13

1,540×2,400

1,540×2,400

1,120×2,170

1,500×2,100

1,120×2,100

1,428×2,400

1,428×2,400

1,428×2,400

900×2,100

900×2,100

900×2,100

900×2,100

1,020×2,400

1,940×2,640

2,000×2,100

1,020×2,400

1,020×2,400

1,020×2,400

1,020×2,400

1,020×2,400

900×2,100

900×2,100

1,020×2,400

1,020×2,400

1,020×2,400

1,500×2,400

GYMNASIUM

STORE

CHANGE

P.A. STORE

P.A. STORE

<Undefined>

<Undefined>

<Undefined>

<Undefined>

CORRIDOR

<Undefined>

CONSULTATION

CONSULTATION

CIRCULATION

MEETING B

MEETING A


CIRCULATION

RESOURCE ROOM

CIRCULATION CIRCULATION

INFORMAL

MEETING

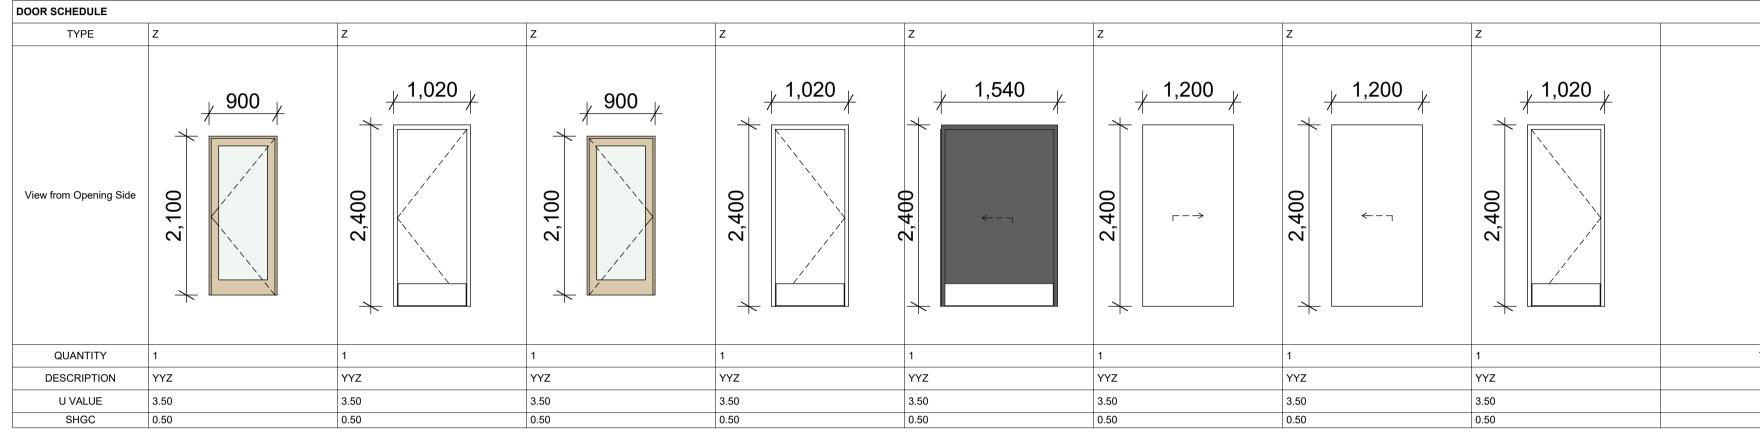

ALL DOORS TO COMPLY WITH A.S.1428.1
ALL DOORS TO ACHIEVE MIN. 850 CLEARANCE
ALL GLAZING TO COMPLY WITH A.S.1288 ALL SPECIFICATIONS TO BE CONFIRMED WITH ENERGY RATING REPORT PREPARED BY: GIW ENVIRONMENTAL SOLUTIONS ALL WINDOWS TO BE ALUMINIUM FRAMED ALL GLAZING TO BE DOUBLE GLAZED UNITS, ARGON FILLED AND CLEAR (U.N.O.) ALL EXTERNAL DOORS TO BE SELF CLOSING. ALL OPERABLE WINDOWS AND DOORS TO HAVE WEATHER SEALS. ALL EXTERNAL WINDOWS AND DOORS TO BE SUPPLIED AND INSTALLED WITH FLYSCREENS. METAL FRAMED POWDERCOAT FINISH TO MATCH WINDOWS. **LEGEND** FIXED GLASS OPENABLE SASH

ALL WINDOWS AND DOORS TO COMPLY WITH

NOTES

A.S. 2040.

TYPES FP FS H CS AS PVT 3P 4P	FLUSH PANEL FACE SLIDER HINGED CAVITY SLIDER AUTO SLIDING PIVOT HINGED DOOR 3 PANEL DOOR LEAF PANELLISED DOOR LEAF
FRAME AL PM	CAPRAL NARROWLINE 425 PRESSED METAL

25 SERIES MIN 35mm THICK SOLID CORE MIN 45mm THICK SOLID CORE ALUMINIUM FRAMED GLASS DOOR 38mm FIRE RATED DOOR MIN 45mm FIRE RATED DOOR

FINISH POWDERCOAT

ACCESS SECURITY CARD ACCESS POINT CLOSER FACE FIX DOOR CLOSER 2 WAY DOOR CLOSER TRANSOM MOUNTED PIVOT CLOSER DORMA EL01 AUTO SLIDING ENTRY DOOR

AUTO-02 FACE SLIDING DOOR AUTO CLOSER SEALS W ACO-01 WEATHERSEALS ACOUSTIC SEALS TO PERIMETER. RAVEN RP-10 TO SIDES AND TOP; RP-38 RECESSED TO BOTTOM. SMOKE SEALS TO N.C.C. REQ'S

ACOUSTIC SEALING TO ACHIEVE

WEIGHTED REDUCTION #SPECIFIED


| GLASS TYPES | CLOSER | 6.38mm | GLAMINATED | 10.38mm | LAMINATED | CLOSER LEAF FINISH DOOR # **Unit Dimensions TYPE** From Zone FRAME FRAME FINISH LEAF **GLASS TYPE** 1,900×3,040 CIRCULATION 10.38mm TOUGHENED LAMINATED 1,900×3,040 CLASSROOM 09 1,540×2,400 CLASSROOM 08 1,500×2,100 CLASSROOM 08 1,500×1,950 1,540×2,400 CLASSROOM 07 KITCHEN 1,900×3,040 1,900×3,040 CAFE/CANTEEN 1,900×3,040 CIRCULATION 1,500×2,100 CLASSROOM 05 1,500×1,950 CLASSROOM 04 CLASSROOM 03 D.LC.13 1,500×1,950 CLASSROOM 02 D.LC.14 CLASSROOM 01 1,428×2,400 1,020×2,400 <Undefined> 1,020×2,400 <Undefined> 1,020×2,400 <Undefined>
 REV
 DATE
 BY
 CH
 DESCRIPTION

 01
 16/07/2021
 FOR QS REVIEW

 02
 27/07/2021
 FOR BUILDING SURVEYOR
 1,200×2,400 CLASSROOM 09 CLASSROOM 08 1,200×2,400 1,200×2,400 ACCESS WC 900×2,100 CLASSROOM 08 900×2,100 CLASSROOM 07 1,200×2,400 CLASSROOM 07 1,200×2,400 1,900×3,040 1,200×2,400 CLASSROOM 06 ---1,200×2,400 CLASSROOM 05 1,200×2,400 <Undefined> 900×2,100 CLASSROOM 05 900×2,100 CLASSROOM 04 1,200×2,400 <Undefined> PRELIMINARY 1,200×2,400 CLASSROOM 04 1,020×2,400 <Undefined> 1,020×2,400 <Undefined> 1,020×2,400 1,200×2,400 CLASSROOM 03 1,200×2,400 <Undefined> D.LC.38 900×2,100 CLASSROOM 03 900×2,100 CLASSROOM 02 1,200×2,400 Fooks Martin Sandow Anson Pty Ltd 1,200×2,400 CLASSROOM 02 Level 2, 182 Capel Street 1,200×2,400 CLASSROOM 01 North Melbourne VIC 3051 1,940×2,640 CORRIDOR 1,200×2,400 <Undefined> T: 03 9329 6555 F: 03 9328 4909 1,938×3,000 1,800×2,100 TECHNOLOGY <Undefined> 2,500×2,100 ABN 44 005 000 859 1,500×2,400 GYMNASIUM

AL/GL

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<u>NOTES</u>

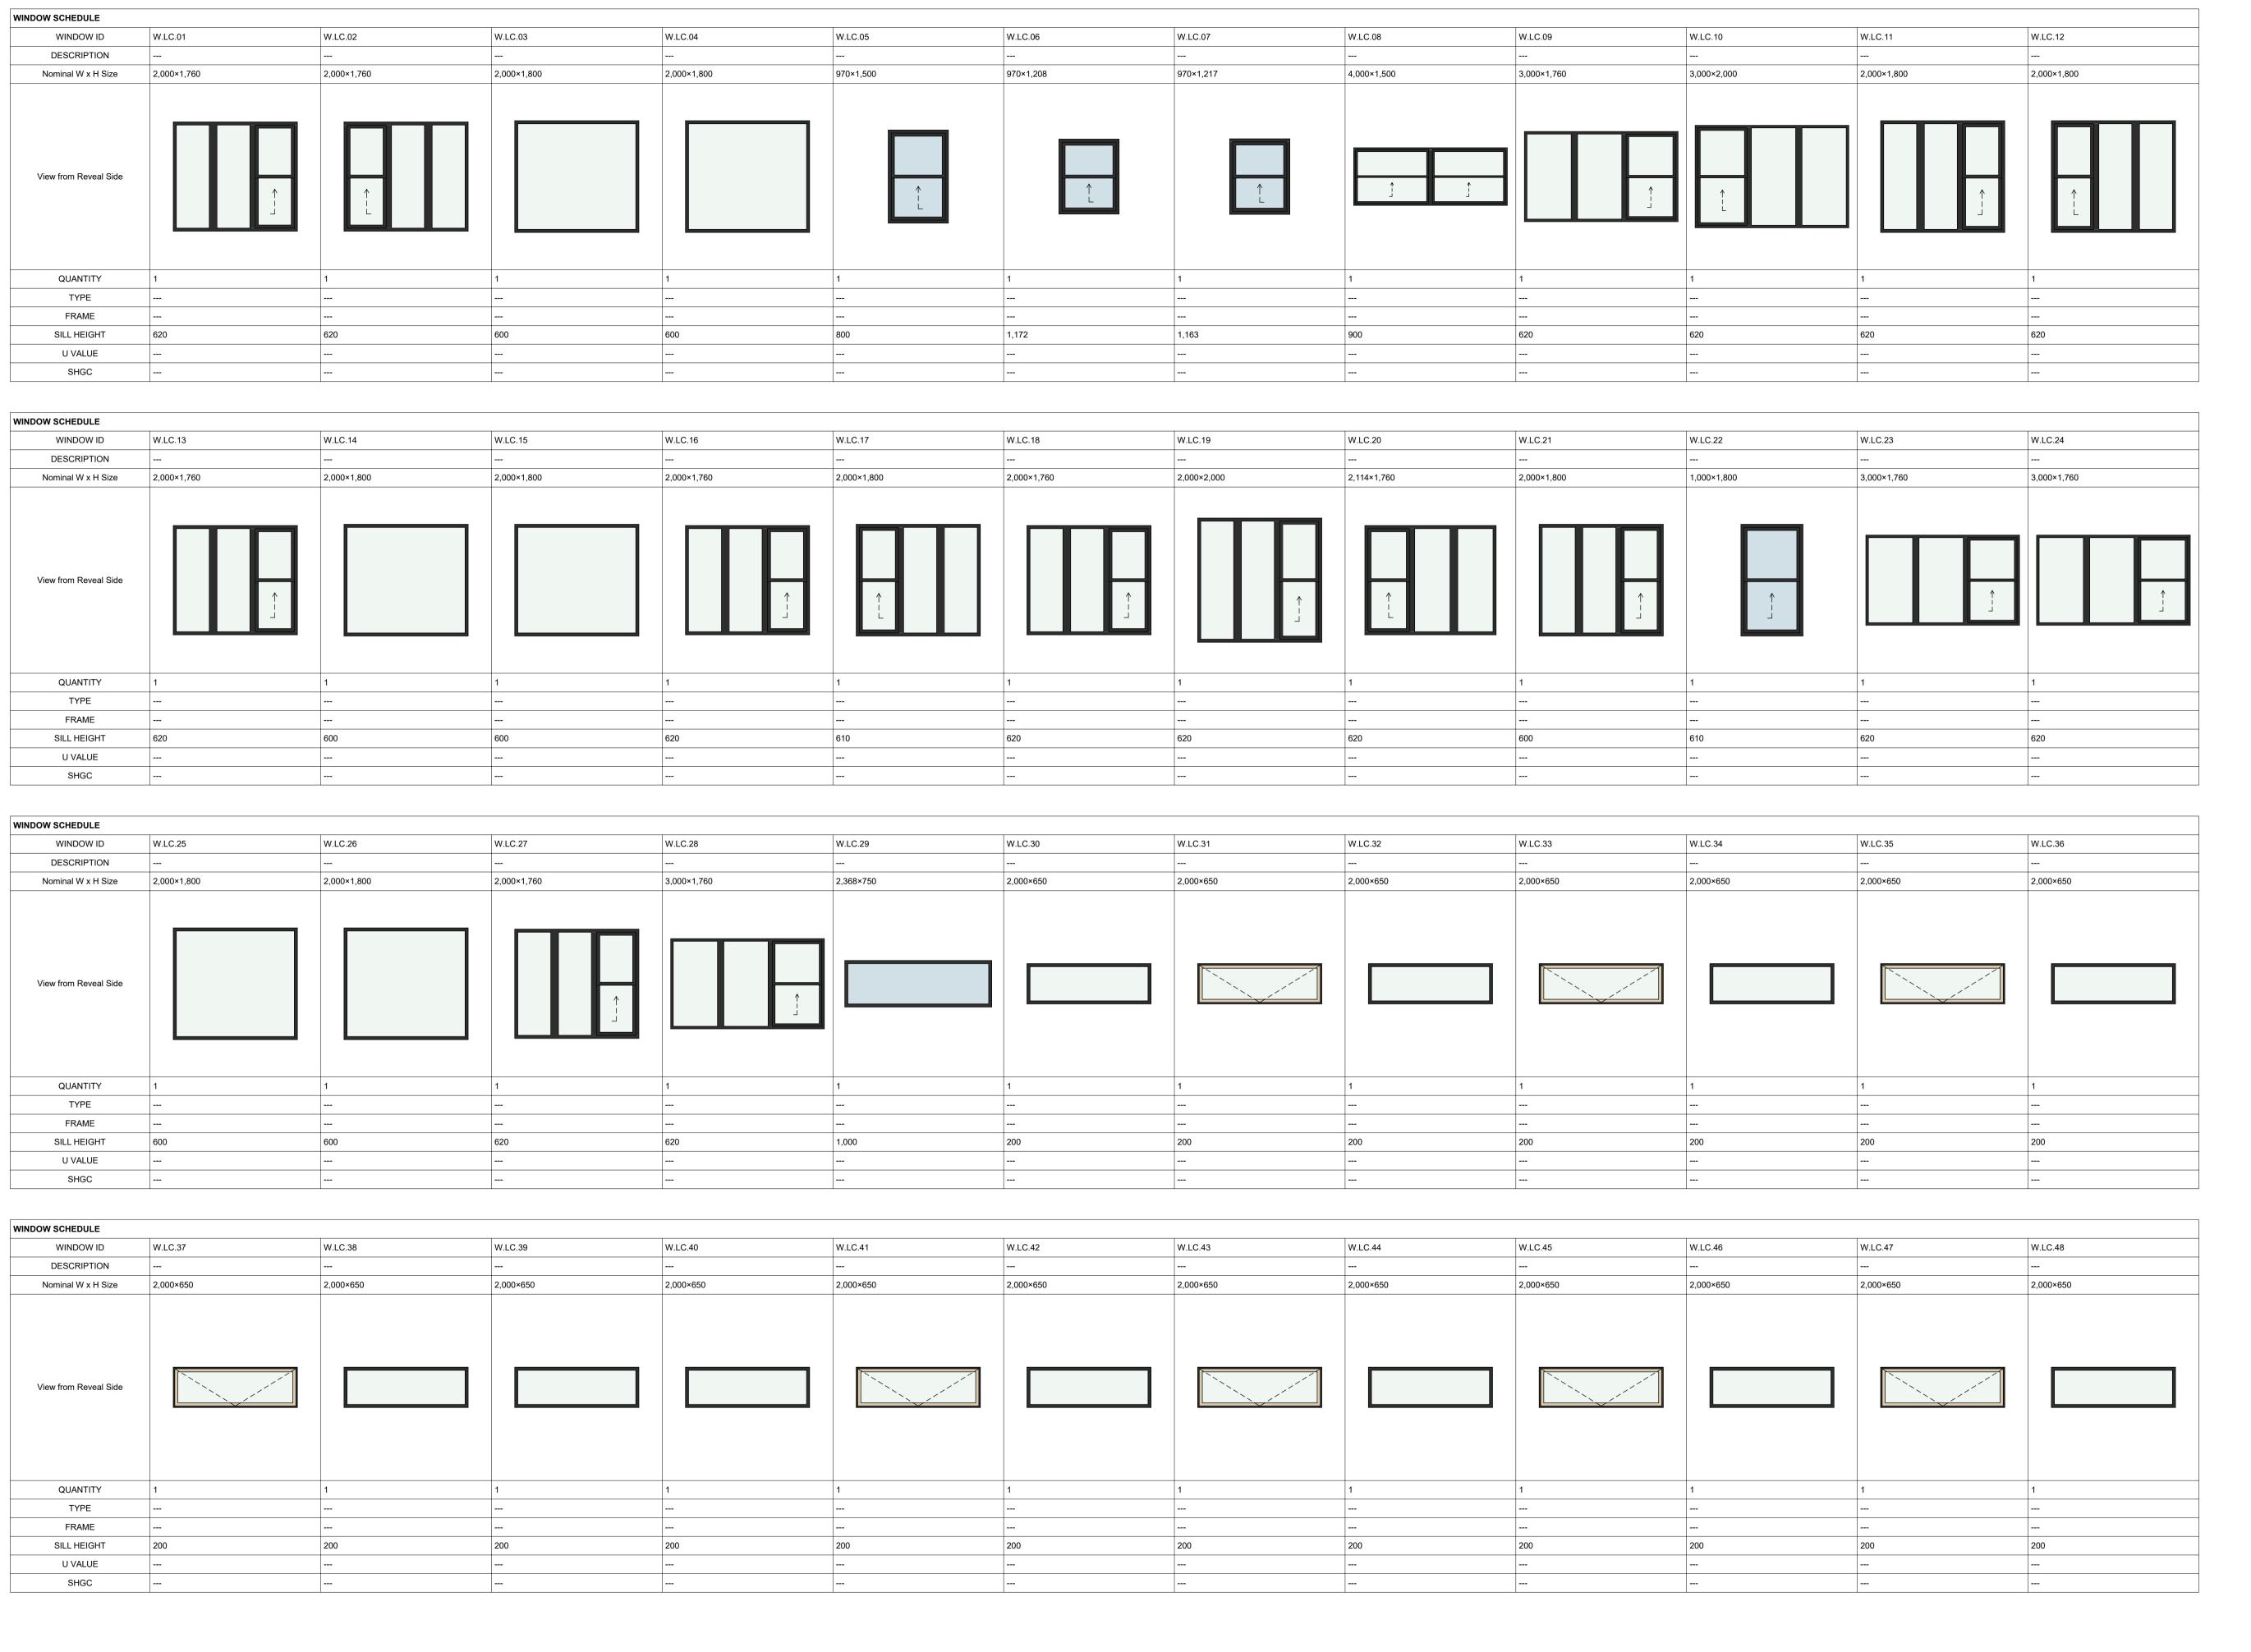ALL WINDOWS AND DOORS TO COMPLY WITH A.S. 2040.
ALL DOORS TO COMPLY WITH A.S.1428.1

ALL DOORS TO COMPLY WITH A.S.1428.1
ALL DOORS TO ACHIEVE MIN. 850 CLEARANCE
ALL GLAZING TO COMPLY WITH A.S.1288
ALL SPECIFICATIONS TO BE CONFIRMED WITH

ENERGY RATING REPORT PREPARED BY:
GIW ENVIRONMENTAL SOLUTIONS

ALL WINDOWS TO BE ALUMINIUM FRAMED

ALL CLAZING TO BE DOUBLE CLAZED UNITS

ALL GLAZING TO BE DOUBLE GLAZED UNITS, ARGON FILLED AND CLEAR (U.N.O.) ALL EXTERNAL DOORS TO BE SELF CLOSING. ALL OPERABLE WINDOWS AND DOORS TO HAVE WEATHER SEALS.

ALL EXTERNAL WINDOWS AND DOORS TO BE SUPPLIED AND INSTALLED WITH FLYSCREENS. METAL FRAMED POWDERCOAT FINISH TO

<u>LEGEND</u>

MATCH WINDOWS.

FIXED GLASS OPENABLE SASH

FLUSH PANEL
FACE SLIDER
HINGED
CAVITY SLIDER
AUTO SLIDING
PIVOT HINGED DOO!

AUTO SLIDING
PIVOT HINGED DOOR
3 PANEL DOOR LEAF
PANELLISED DOOR LEAF

PANELLISED DOOR LEAF

ME

CAPRAL NARROWLINE 425 SERIES
PRESSED METAL

EAF
C MIN 35mm THICK SOLID CORE
C4 MIN 45mm THICK SOLID CORE
L/GL ALUMINIUM FRAMED GLASS DOOR
R 38mm FIRE RATED DOOR
R4 MIN 45mm FIRE RATED DOOR

FINISH
P PAINT
PC POWDERCOAT

SECURITY
ACCESS SECURITY CARD ACCESS POINT

CLOSER
CL FACE FIX DOOR CLOSER
CL-02 2 WAY DOOR CLOSER
TR TRANSOM MOUNTED PIVOT CLOSER
AUTO DORMA EL01 AUTO SLIDING ENTRY DOOR
AUTO-02 FACE SLIDING DOOR AUTO CLOSER

SEALS W WEACO-01 ACC

WEATHERSEALS
O1 ACOUSTIC SEALS TO PERIMETER.
RAVEN RP-10 TO SIDES AND TOP;
RP-38 RECESSED TO BOTTOM.
SMOKE SEALS TO N.C.C. REQ'S
ACOUSTIC SEALING TO ACHIEVE
WEIGHTED REDUCTION #SPECIFIED

 GLASS TYPES

 6L
 6.38mm LAMINATED

 10L
 10.38mm LAMINATED

10L 10.38mm LAMINATED 10TL 10.38mm TOUGHENED LAMINATED

	_		_	
			_	
REV	DATE	BY	CH	DESCRIPTION
01	16/07/2021	JP	JM	FOR QS REVIEW
02	27/07/2021	JP	JM	FOR BUILDING SURVEYOR

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PROJECT ADDRESS
76-94 Laura Ave

76-94 Laura Ave, Belmont VIC 3216

Victorian School Building Authority

CAD FILE 2105 BVS Stage 2 - DD PROJECT

Barwon Valley School - Stage 2

TITLE

Window Schedule 01

2105		DD.07.02	:	02
PROJECT	I	DWG NO.	1	REV
PLOT DATE		27/07/2021		
CHECKED		JM		
DRAWN		JP		
SCALE		1:100@ A1		

Element ID	Building Materials (All)	THICKNESS [m]	WALL SCHEDULE 2D Plan Preview	2D Cross Section Preview Fire Resistance Level	Sound Transmission Class
B01	Brick Black; Air Space - Frame; Timber Stud + Insulation; Plasterboard - Wall	263			<undefined></undefined>
E01	Cladding - Corrugated Walling; Steel - Stud; Gypsum Plasterboard	188			<undefined></undefined>
E02	Cladding - WALL BAND BLACK; Steel - Stud; Gypsum Plasterboard	115			<undefined></undefined>
E03	Corrugated Cladding - WHITE; Cavity Space - Batten; Membrane - Rainproof; Plasterboard - Wall; Fire Proofing; Steel - Stud + Insulation; Plasterboard - Wall	173			<undefined></undefined>
S01	Gypsum Plasterboard; Steel - Stud; Gypsum Plasterboard	118			30 Rw
S02	Plasterboard - Wall; Steel - Stud + Insulation; Plasterboard - Wall	118			35 Rw
S03	Plasterboard - Wall; Plasterboard - Wall; Steel - Stud + Insulation; Plasterboard - Wall	131			40 Rw
S04	Plasterboard - Wall; Plasterboard - Wall; Steel - Stud + Insulation; Plasterboard - Wall; Plasterboard - Wall	144			45 Rw
S05	Plasterboard - Wall; Plasterboard - Wall; Steel - Stud + Insulation; Air Space; Steel - Stud + Insulation; Plasterboard - Wall; Plasterboard - Wall	318			50-55 Rw

REV DATE BY CH DESCRIPTION
01 27/07/2021 JP JM FOR BUILDING SURVEYOR

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PROJECT ADDRESS

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Victorian School Building Authority

CAD FILE 2105 BVS Stage 2 - DD

Barwon Valley School - Stage 2

Walls Schedule

SCALE 1:1@ A1 DRAWN JP CHECKED JM PLOT DATE 27/07/2021 PROJECT DWG NO. | REV 2105

DD.07.04 | 01

DOW SCHEDULE												
WINDOW ID	W.LC.49	W.MT.01	W.MT.02	W.MT.03	W.SH.01	W.SH.02	W.SH.03	W.SH.04	W.SH.05	W.SH.06	W.SH.07	W.SH.08
DESCRIPTION												
Nominal W x H Size	1,200×650	1,500×1,800	1,500×1,800	1,500×1,800	2,000×1,760	2,000×1,760	2,000×1,760	2,000×1,760	2,000×1,760	2,000×1,760	400×400	550×550
View from Reveal Side												
QUANTITY	1	1	1	1	1	1	1	1	1	1	1	1
TYPE												
FRAME												
SILL HEIGHT	200	600	600	600	620	620	620	620	620	620	1,000	1,500
U VALUE												
SHGC												

INDOW SCHEDULE												
WINDOW ID	W.SH.09	W.SH.11	W.SH.12	W.SH.13	W.TH.01	W.TH.02	W.TH.03	W.TH.04	W.TH.05	W.TH.06	W.TH.07	W.TH.08
DESCRIPTION												
Nominal W x H Size	700×700	2,000×1,760	2,000×1,760	2,000×1,760	970×1,780	970×1,780	970×1,780	3,000×1,180	2,200×1,180	2,988×1,180	2,200×1,180	1,637×1,180
View from Reveal Side									3			
QUANTITY	1	1	1	1	1	1	1	1	1	1	1	1
TYPE												
FRAME												
SILL HEIGHT	620	620	620	620	620	620	620	1,200	1,200	1,200	1,200	1,200
U VALUE												
SHGC												

W.TH.15

W-SH-10

W.TH.14

W.TH.13

WINDOW SCHEDULE

WINDOW ID

W.TH.09

W.TH.10

W.TH.11

W.TH.12

ALL EXTERNAL WINDOWS AND DOORS TO BE SUPPLIED AND INSTALLED WITH FLYSCREENS.
METAL FRAMED POWDERCOAT FINISH TO MATCH WINDOWS. **LEGEND** FIXED GLASS OPENABLE SASH TYPES
FP
FS
H
CS
AS
PVT
3P
4P FLUSH PANEL FACE SLIDER HINGED
CAVITY SLIDER
AUTO SLIDING
PIVOT HINGED DOOR
3 PANEL DOOR LEAF
PANELLISED DOOR LEAF CAPRAL NARROWLINE 425 SERIES PRESSED METAL MIN 35mm THICK SOLID CORE MIN 45mm THICK SOLID CORE ALUMINIUM FRAMED GLASS DOOR 38mm FIRE RATED DOOR MIN 45mm FIRE RATED DOOR FINISH P PC PAINT POWDERCOAT SECURITY ACCESS SECURITY CARD ACCESS POINT CLOSER
CL FACE FIX DOOR CLOSER
CL-02 2 WAY DOOR CLOSER
TR TRANSOM MOUNTED PIVOT CLOSER
AUTO DORMA EL01 AUTO SLIDING ENTRY DOOR
AUTO-02 FACE SLIDING DOOR AUTO CLOSER SEALS
W WEATHERSEALS
ACO-01 ACOUSTIC SEALS TO PERIMETER.
RAVEN RP-10 TO SIDES AND TOP;
RP-38 RECESSED TO BOTTOM.
SM SMOKE SEALS TO N.C.C. REQ'S
RW# ACOUSTIC SEALING TO ACHIEVE
WEIGHTED REDUCTION #SPECIFIED
 GLASS TYPES

 6L
 6.38mm LAMINATED

 10L
 10.38mm LAMINATED

 10TL
 10.38mm TOUGHENED LAMINATED

NOTES

WEATHER SEALS.

ALL WINDOWS AND DOORS TO COMPLY WITH

A.S. 2040.
ALL DOORS TO COMPLY WITH A.S.1428.1
ALL DOORS TO ACHIEVE MIN. 850 CLEARANCE
ALL GLAZING TO COMPLY WITH A.S.1288

ALL SPECIFICATIONS TO BE CONFIRMED WITH ENERGY RATING REPORT PREPARED BY:
GIW ENVIRONMENTAL SOLUTIONS

ALL WINDOWS TO BE ALUMINIUM FRAMED
ALL GLAZING TO BE DOUBLE GLAZED UNITS,
ARGON FILLED AND CLEAR (U.N.O.)

ALL EXTERNAL DOORS TO BE SELF CLOSING.
ALL OPERABLE WINDOWS AND DOORS TO HAVE

REV DATE BY CH DESCRIPTION
01 27/07/2021 JP JM FOR BUILDING SURVEYOR

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PROJECT ADDRESS 76-94 Laura Ave, Belmont VIC

3216

Victorian School Building Authority

ARBV 50053

CAD FILE 2105 BVS Stage 2 - DD

Barwon Valley School - Stage 2

Window Schedule 02

SCALE 1:1, 1:100@ A1 DRAWN CHECKED JM PLOT DATE 27/07/2021 PROJECT DWG NO. | REV

2105

DD.07.04 | 01

29. Area Analysis

The proposed areas of the new build align with the School Facilities Area Schedule & thus shows that the school's Stage 2 proposed design is to entitlement albeit the Learning Base entitlements which are slightly over due to the size of the existing Amenities. The request at SD PREP for larger Classrooms and subsequent request from the school for additional toilets.

The outdoor circulation remains over-entitled as per existing conditions & the Hydrotherapy building has been allocated as no-entitlement space as agreed in principle during the AMP2 Refresh stage.

Please refer to the Excel spreadsheet file of the Form 15 provided separately.

2105 1.4.3 BVS DD Report Final.Docx Page | 45



Sch	Schedule		Variance Actual -	Proposed	Variance Proposed -	
Spaces	Area	Area	Schedule	Total Area	Schedule	Comments
no	(eam)	(sam)	(sam)	(sam)	(sam)	

Learning Base							
Shared Learning		1,652	1,133	ı	1,769		
Practical Activities Consult/Sensory/Withdrawal		168 150	88 187		168 203		
Relocatable Buildings - Learning Base		-	643		-		
Circulation/Informal Learning		397	- 4.400	(500)	397	170	
Sub Total: Permanent Learning Base pre Circulation/Informal Learnin Sub Total: Permanent Learning Base incl. Circulation/Informal Learnin		1,970 2,367	1,408 1,408	(562) (959)	2,140 2,537	170 170	
Sub Total: Relocatable Learning Base		-	643	643	-	-	
Total: Learning Base	-	2,367	2,050	(317)	2,537	170	
Resource Intensive Learning						(
Practical Activities - Art/Science/Technology/Food Preparation		-	- 470		-		
Practical Activities - Art Practical Activities - Science/Technology		160	176		160		
Practical Activities - Science		135	-		135		
Practical Activities - Materials Technology		105 110	- 101		105 110		
Practical Activities - Food Technology Practical Activities - Media and Visual Communications		105	-		105		
Integrated Resource Intensive Learning		100	7		100		
Relocatable Buildings - Resource Intensive Learning Circulation/Informal Learning		107	41		107		
Sub Total: Permanent Resource Intensive Learning pre Circulation/Informal Learning	j -	715	284	(431)	715	-	
Sub Total: Permanent Resource Intensive Learning incl. Circulation/Informal Learning		822	284	(538)	822	-	
Sub Total: Relocatable Resource Intensive Learning Total: Resource Intensive Learning		822	41 325	(497)	822	-	
- Call Resource Microsite Edulinia		OLL	020	(101)	OLL		
School Community Hub							
Fitness Room Multi-Purpose Space		60	145		60		
Physical Education Gymnasium		280	332		280		
Storage		40	-		40		
Performing Arts/Music Canteen		210 69	- 11		210		
Relocatable Buildings - School Community Hub		-	-		-		
Circulation/Informal Learning		66	-		66		
Sub Total: Permanent School Community Hub pre Circulation/Informal Learnin Sub Total: Permanent School Community Hub incl. Circulation/Informal Learnin	1	659 725	488 488	(171) (237)	659 725	0	
Sub Total: Permanent School Community Hub Incl. Sinculated Infinition and Learning		-	-	(201)	-	-	
Total: School Community Hul	-	725	488	(237)	725	0	
Learning Resource Centre						1	
Library		165	96		165		
Relocatable Buildings - Learning Resource Centre		-	-		-		
Circulation/Informal Learning Sub Total: Permanent Learning Resource Centre incl. Circulation	-	25 190	96	(94)	25 190	-	
Total: Learning Resource Centre		190	96	(94)	190	-	
Administration				í I			
Senior Personnel Work Area		162	107		162		
Support Spaces/Meeting Rooms		66	52		66		
Staff Centre First Aid		153 40	142 15		153 40		
Relocatable Buildings - Staff Centre		-	15		-		
Relocatable Buildings - Administration		-	12		-		
Circulation/Foyer Sub Total: Permanent Administration pre Circulation		126 421	316	(105)	126 421		
Sub Total: Permanent Administration incl. Circulation		547	316	(103)	547	-	
Sub Total: Relocatable Administration		-	12	12	-	-	
Sub Total: Administration	-	547	327	(220)	547	-	
Staff Work						[
Staff Work		241	222		241		
Relocatable Buildings - Staff Work Sub Total: Permanent Staff Work	-	241	13 222	(19)	- 241	-	
Total: Staff Work		241	235	(6)	241	-	
Student and Staff Amenities							
Staff Amenities (Toilets, Shower, Change)		77	59	1	77		
Student Amenities (Toilets, Shower, Change)		40	315		40		
Relocatable Buildings - Student and Staff Amenities Sub Total: Permanent Student and Staff Amenities	5 -	- 117	51 374	257	- 117	0	
Total: Student and Staff Amenities		117	425	308	117	0	
Cleaning, Maintenance & Storage						-	
Cleaning, Maintenance & Storage Cleaning, Maintenance & Storage		53	34		53		
Transport Entrance		30	-		30		
Bus Shelter Relocatable Buildings - Cleaning, Maintenance & Storage		210	-		210		
Sub Total: Permanent Cleaning, Maintenance & Storage	-	293	34	(259)	53	(240)	
Total: Cleaning, Maintenance & Storage		293	34	(259)	53	(240)	
Circulation							
Distributed Circulation		151	1,653	1,502	151	-	
Constant Outdoor of Outdoor T				 			
Covered Outdoor and Outdoor Travel Outdoor Travel		206	684	478	544	338	
Canteen Serving/Eating Area			30.	3	-	200	
Outdoor Travel - Permanent		-	-	-	-	-	
Outdoor Travel - Relocatable Sub Total: Permanent Covered Outdoor and Outdoor Trave	_	206	684	478	- 544	338	
Total: Covered Outdoor and Outdoor Trave		206	684	478	544	338	
9999 - No Entitlement and Community Space			334	1	572	Г	
росси по впинения ана общинину орасе	<u> </u>	<u> </u>	334		2/2		
Total Area	38			992	6,499	840	
Total Circulation - Internal Permanent Total Permanent Area (excl. Permanent Internal Circulation)	- 38	872 4,787	1,653 3,905	781 (882)	872 5,056	269	
Total Permanent Area (exc. Permanent Internal Circulation) Total Permanent Area	38	5,659	5,558	(101)	5,056	269	
Total Relocatable Area	-	-	759	759	-	-	
Total Area (excl. No Entitlement and Community Space Area) Total Permanent Internal Area (incl. Internal Circulation, excl. Outdoor and Non-scheduled)	38	5,659 5,453	6,317 4,874	658 (579)	5,928 5,384	269 (70)	
Total Covered Outdoor and Outdoor Travel	-	206	684	478	544	338	
Total No Entitlement and Community Space Area	-		334		572		

30. Safety in Design

Please refer to following Safety in Design Checklist along with a copy of *Form 05: School Occupational Health and Safety* Letter endorsed for and on behalf of the school council.

A copy of the Safety in Design Report & Register Appendix has also been included.

31. Cost Plan C

Please find following a copy of the summary page from the Cost Plan B spreadsheet prepared by the Quantity Surveyor along with the Schematic Design PBE prepared by the VSBA.

A full copy of the Cost Plan spreadsheet and Form 16 is provided separately.

32. VSBA Cost Plan Template

Refer to the following Cost Plan Template.

33. Form 16: Cost Plan Summary Analysis in Excel format

Refer to the Form 16: Cost Plan Summary Analysis.

34. Special Factors

The special factors identified in the Cost Plan are considered normal and there no additional supporting information has been provided.

34. IMTD Consultation

Refer to following IMTD, feedback will be incorporated at tender documentation stage.

36. SSU Consultation

Drawings have been sent to SSU and feedback will be incorporated at tender documentation stage.

38. School Endorsement


Please find following a copy of the School's endorsement of this Design Development Report.


39. Services & Maintainability Report

Please find following a copy of the Services & Maintainability Report updated for Design Development.

40. Form 35 School Contributions

There are no school contributions so this is not applicable.

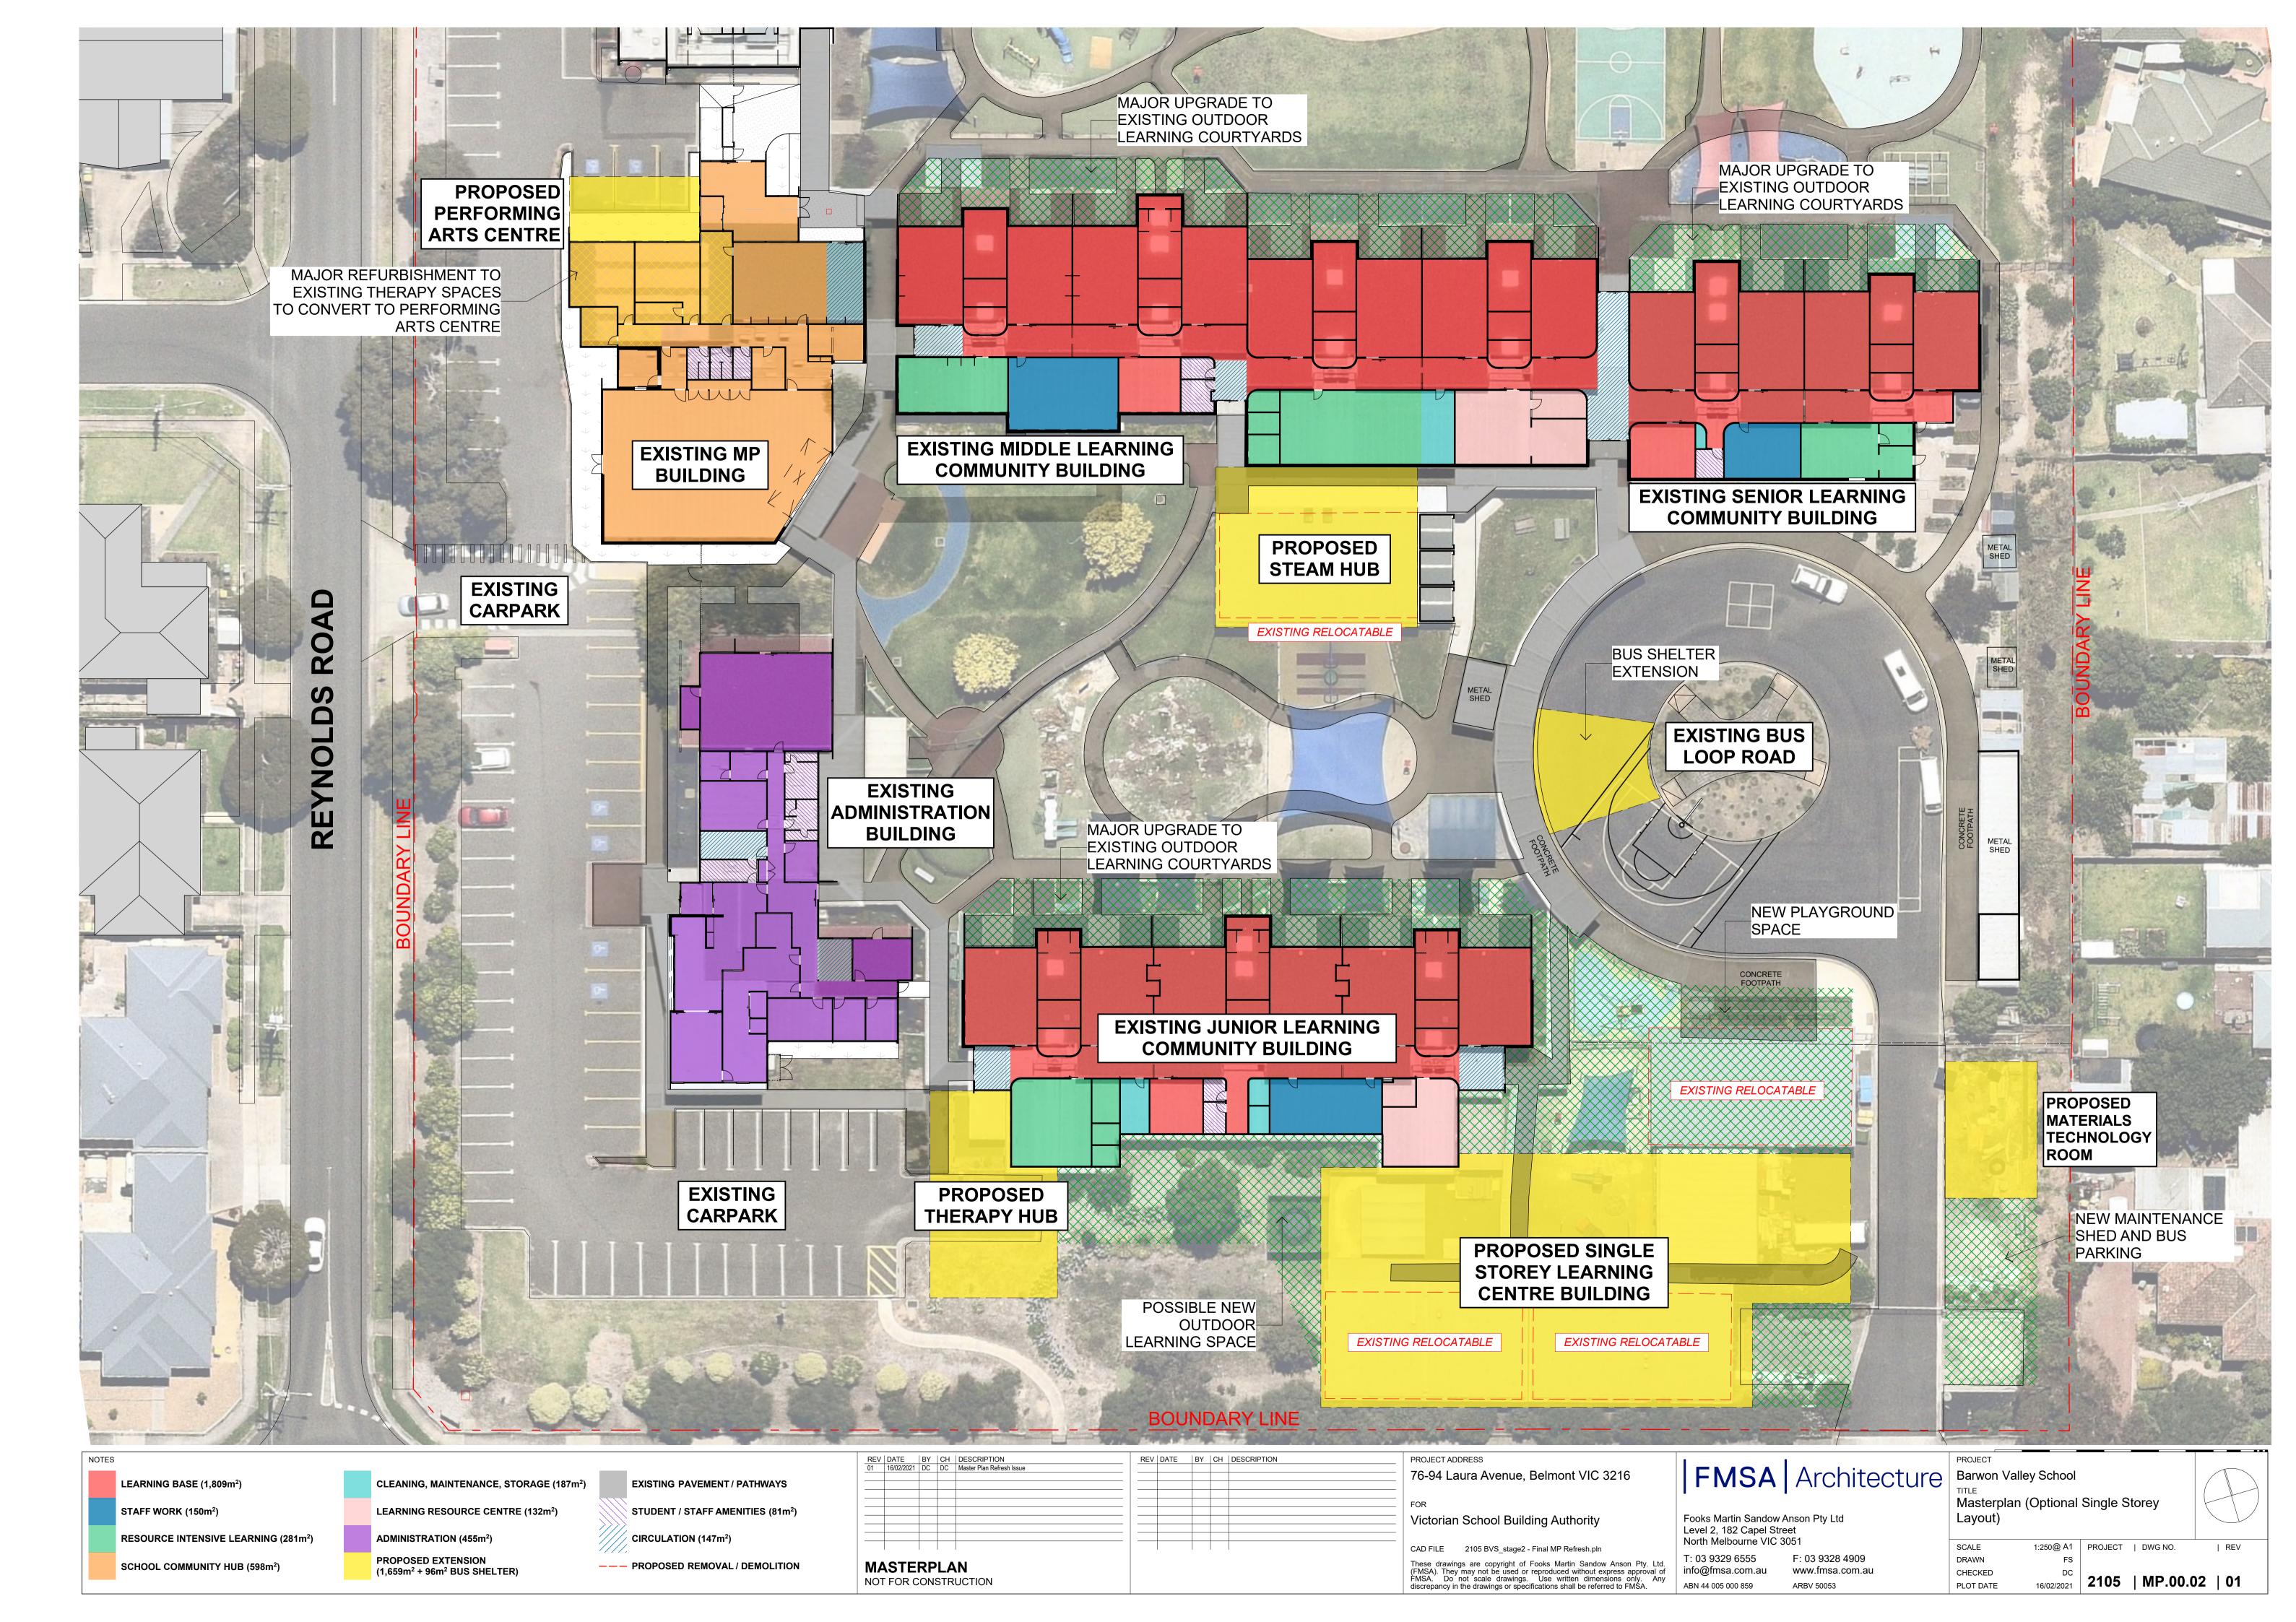

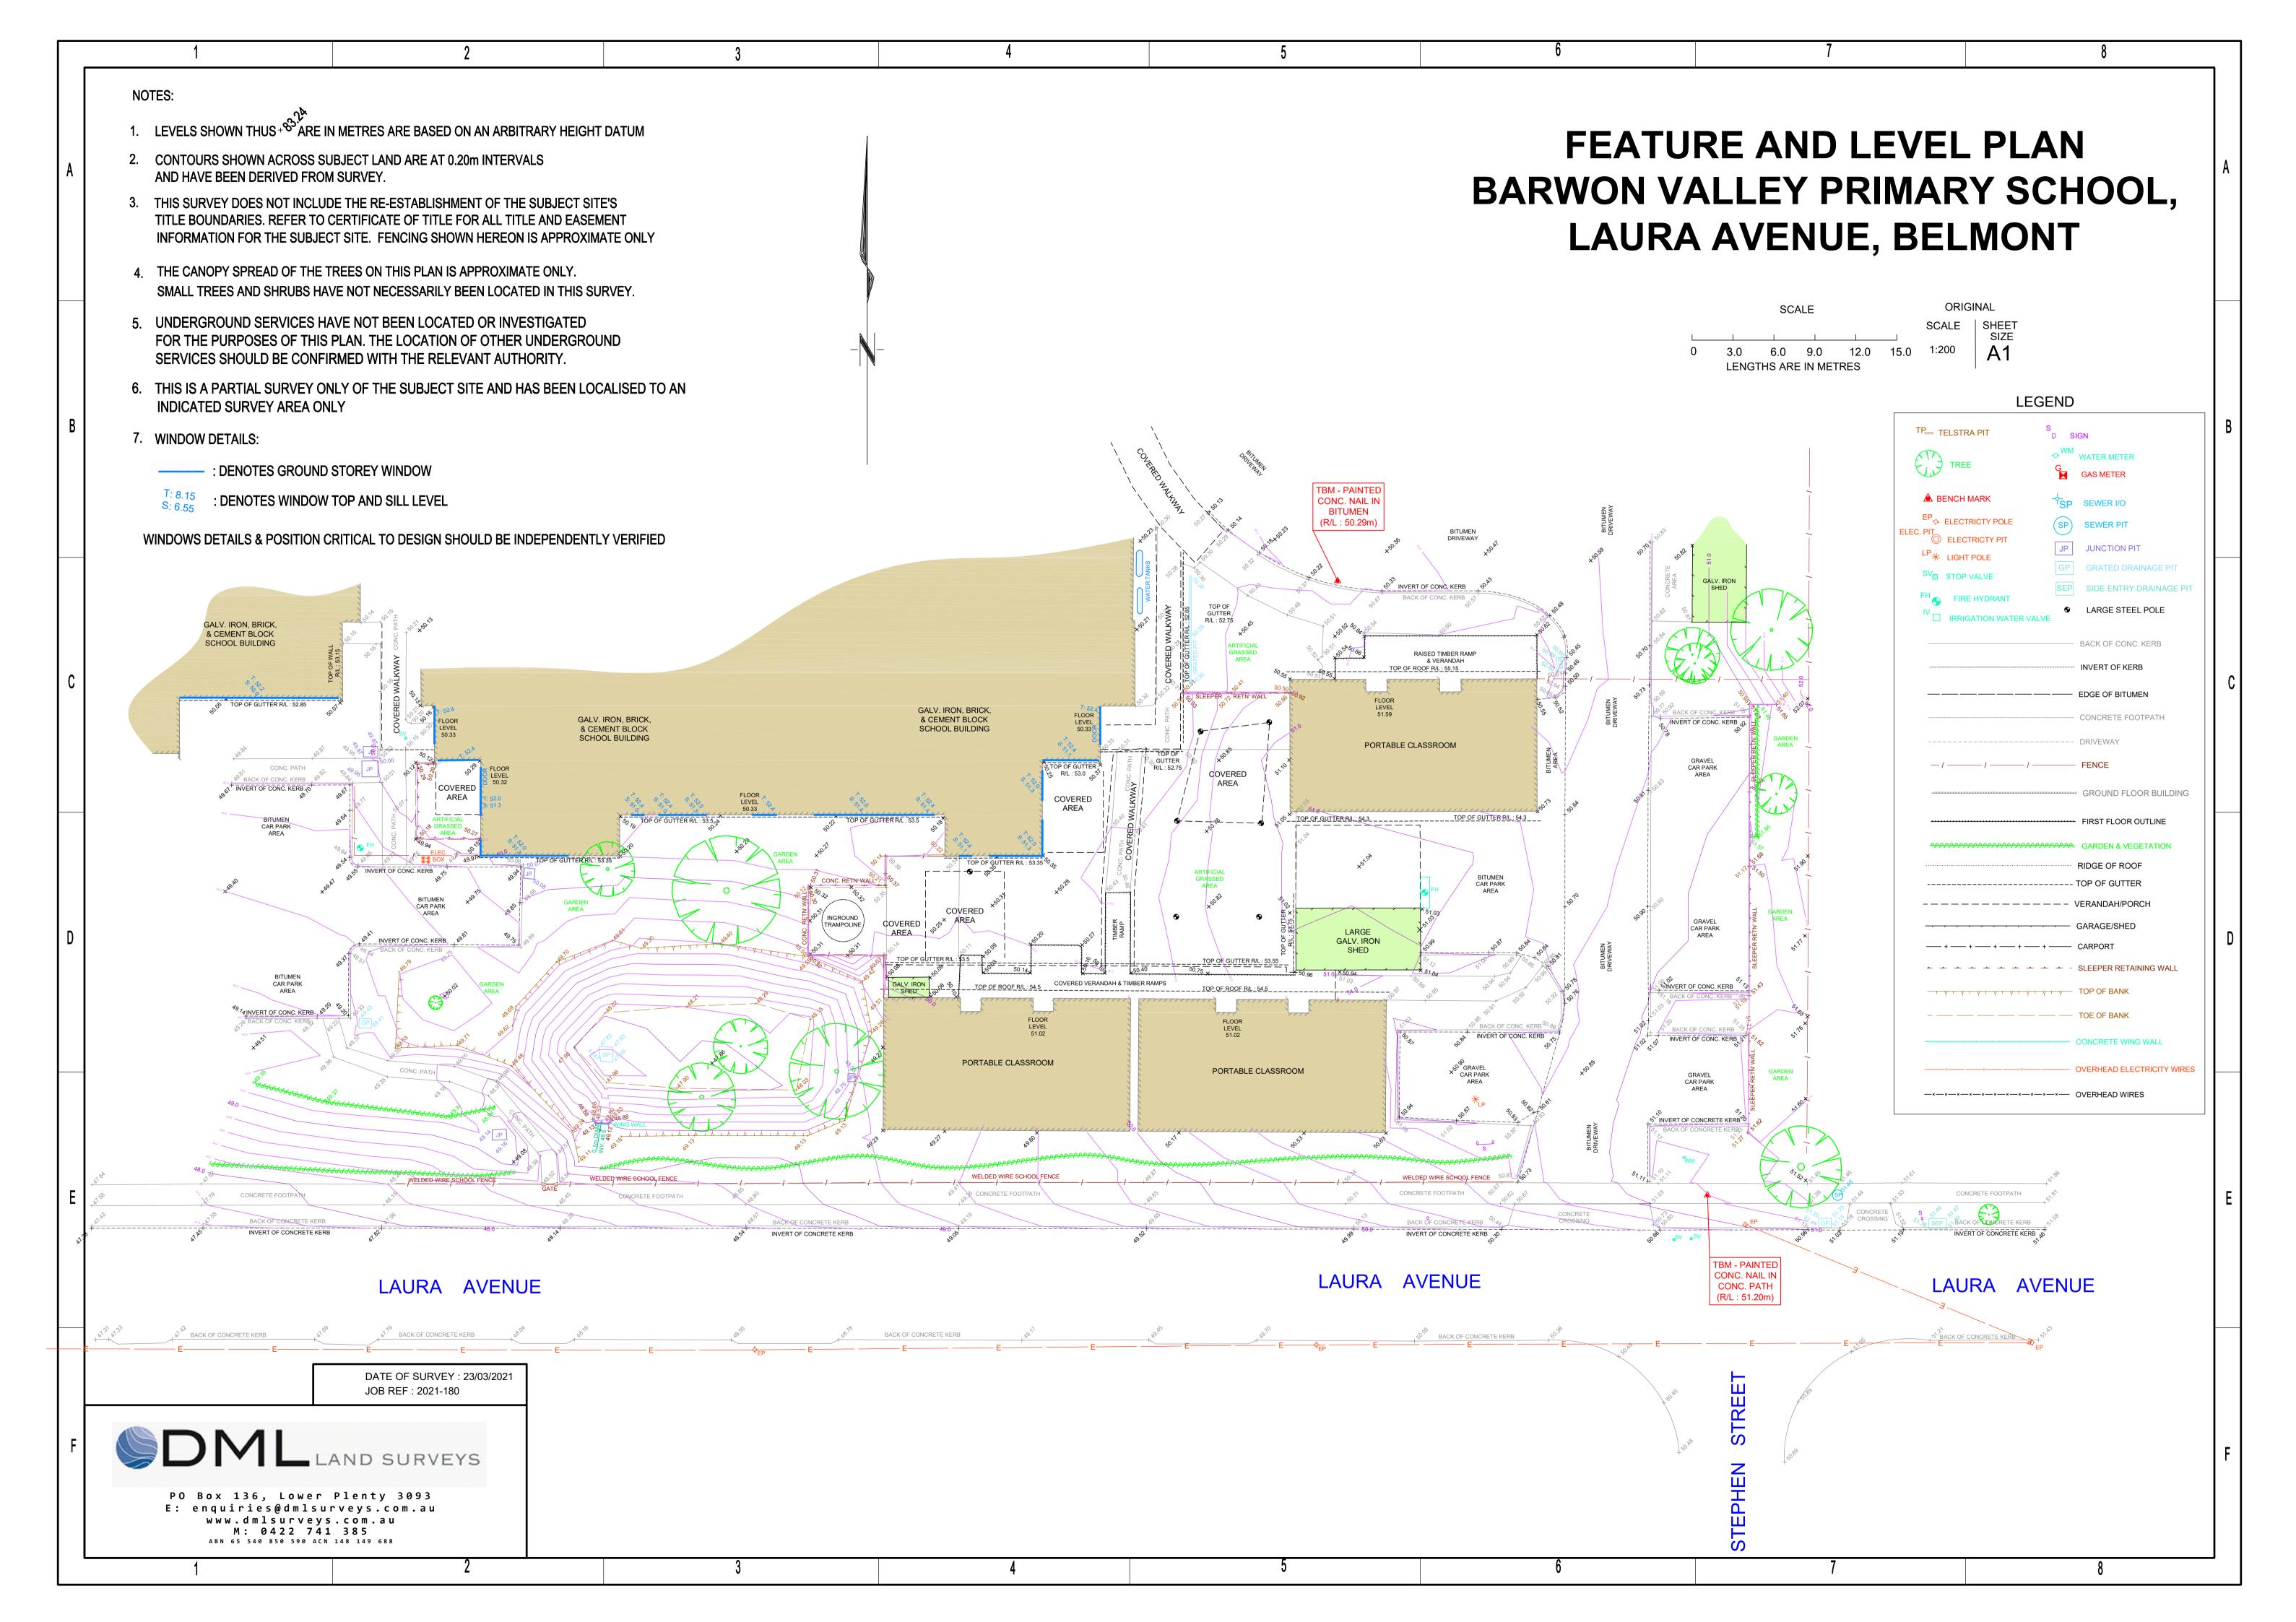

Barwon Valley School

Sketch Design Report

Report No. 01 – Revision 02

Client: Victorian School Building Authority

Date: 27th of April 2021

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FMSA Architecture

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Revision:	Issue Description:	Date:	
01	SD Report Issue	27 th of April 2021	
02	SD Report Issue Rev. 02	30 th of April 2021	



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FMSA Architecture

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ExecutiveSummary

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1. Project Summary & School Profile

Fooks Martin Sandow Anson Pty Ltd (FMSA Architecture) has been engaged by the Victorian School Building Authority to provide Architectural and other required specialist consultancy services for major renovations to Barwon Valley School.

Barwon Valley School (BVS) is embedded within a cluster of twelve schools in the suburb of Belmont; the only one which facilitates the education of children with moderate to profound intellectual disabilities. Located 6km South-West of the Geelong central business district, it enjoys strong community relationships with businesses, service providers & other local schools. Such ties foster community respect, which builds student dignity & validates them as authentic contributors to society.

Barwon Valley School is an active member of the broader state-wide special education community through their PASS membership & through involvement in initiatives such as developing curriculum for students with special learning needs.

Staff – with the assistance of student parents & carers – work & learn together to maximise student potential through the implementation of distinct & effective teaching strategies / support systems.

The school's entry is currently situated along Reynolds Road, however Laura Avenue has some accessible pathways that lead to the reception.

As of 2021, the School's current student enrolment is 224 which includes all ages between five & eighteen. The school's workforce includes 39 teachers, 40 Education Support staff, 2 part-time nurses, 1 wellbeing officer and 13 Therapists (OTs, SPs and PTs).

The most prominent mode of public transport in the area are buses, with the 42-line bus stop that runs West of the site along S Valley & Roslyn Roads. The closest bus

stop is along the former & is 2.5km away. There has been a reported increase of vehicular drop-offs of students by their parents or carers to the school gate.

Concerns currently faced by the Barwon Valley School is the over-reliance on relocatable classrooms. There is a push to establish permanent school infrastructure. Among other issues that will be addressed in this Stage 2 phase is the upgrade of the existing multi-purpose building into a Performing Arts space and a moderate upgrade of the Middle Years Module. Discussions with the staff have also revealed that there needs to be a focus on updating the school's STEAM facilities, as well as providing a new space for Therapy. The current school Therapy Hubs are scattered throughout the school grounds which have been deemed impractical. Stage 2 scope will include extension works that would see the Therapy Hubs clustered into a singular monocentric space. Other works include improving the school's links with the local community; achieved with the implementation of a food tech hub adjacent to the Learning Centre. This hub will be intwined with a new Canteen which will not only facilitate the student's lunch & recess nutritional needs, but also providing a food & beverage service to the general public outside of school hours; a motive that aims to validate the students' place in society as a reliable & strong contributor.

Teachers have expressed the need to further improve the flexibility in teaching methodology. Given the specialised needs of the students at Barwon Valley School, flexibility of learning is paramount & the facilities must be designed to facilitate this successfully & effectively. This flexibility of learning includes group learning activities & independent learning & reflection.

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The following proposals will form the scope for Stage 2 works:

- Performing Arts retrofit into existing "gymnasium".
- New Gymnasium extension into existing Paramedic workshop & Therapy offices
- New STEAM Hub (Science, Technology, Engineering, Art & Mathematics)
- New Therapy Hub
- New Learning Centre with Materials Technology space & Food Technology & Café servery for public culinary consumption
- Localised retrofitting works of existing infrastructure & minor relandscaping works

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2. School and Project Team

A list of the school representatives and the project consulting team involved in the Stage 2 works is as follows:

School:

Barwon Valley School - 03 5243 1813

Not Relevant

Not Relevant

Not Relevant

Future potential Consultants:

- Geotechnical Consultant
- Acoustic Consultant
- Sustainability Consultant













3. Changes since Asset Management Plan (Phase 2)

The scope of works closely aligns with the Asset Management Plan (Phase 2) Refresh. Internal spatial relationships have been developed further following additional consultation with the school, but generally align with the AMP2 Refresh Masterplan (single storey Learning Centre Option).

The only substantive changes since AMP2 Refresh are the following measures:

- Refinement of all proposed extension's building footprints that accommodates entitlements of the school in accordance to the School Facilities Area Schedule
- · Further development of design vernacular
- Detachment of STEAM Hub from existing building infrastructure
- Allocation of entitlements into existing infrastructure i.e. Classroom supplantation of existing Arts & Crafts room
- Strategic orientation of classrooms & other proposed buildings to adhere to BQSH requirements i.e. minimisation of exposure to North / West sun glare

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Existing Conditions

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4. Buildings

The school was constructed in 2006 & remain in good condition.

The previous Stage 1 works scope included a focus on maintenance works around the school which included paintworks, minor roof leak reparations, eaves gutter clean-out maintenance, repainting of steel fascias & doors that jam which is suspected to be due to the site's reactive soils.

Upon the State 2 site inspection, no dilapidation was identified by FMSA Architecture, nor were any issues or concerns raised by the school representatives.

There is however a need for reconfiguration of existing spaces to better accommodate the students needs & allow for flexible learning opportunities. This is perhaps most identifiable in the existing Arts Room; located within the Middle School Campus. The storage areas, work benches & wet areas are in poor condition & do not adequately facilitate the school equipment nor the student's physical restrictions i.e. non-compliant benchtop heights.

The existing Sensory Rooms have been identified as lacking natural light & spatial adequacy. This was identified in the Architect's site inspection & it was noted that the spaces appear elongated & not diverse in its space, thus impeding staff attempts to diversify these areas to adapt to student's individual needs.

Access compliance remains a key priority for the school, given its student demographic. Due to the reactive clays & soils on site, the school maintains an attentive & diligent approach to ensuring that all arterial pathways & access to existing buildings are compliant to the Disability Discrimination Act (DDA).

It is known by the Design Consultants that the existing buildings on site are not Section J-compliant as they were constructed in 2006. They nonetheless provide a good level of energy efficiency, achieved through adequate wall & ceiling insulation & a slab-on-

ground construction methodology. Some minor retrofitting of existing spaces will be proposed in Stage 2 & continual collaboration between the Design Consultants & relevant Authorities will be necessary to ensure that compliance to relevant codes are upheld & maintained.

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